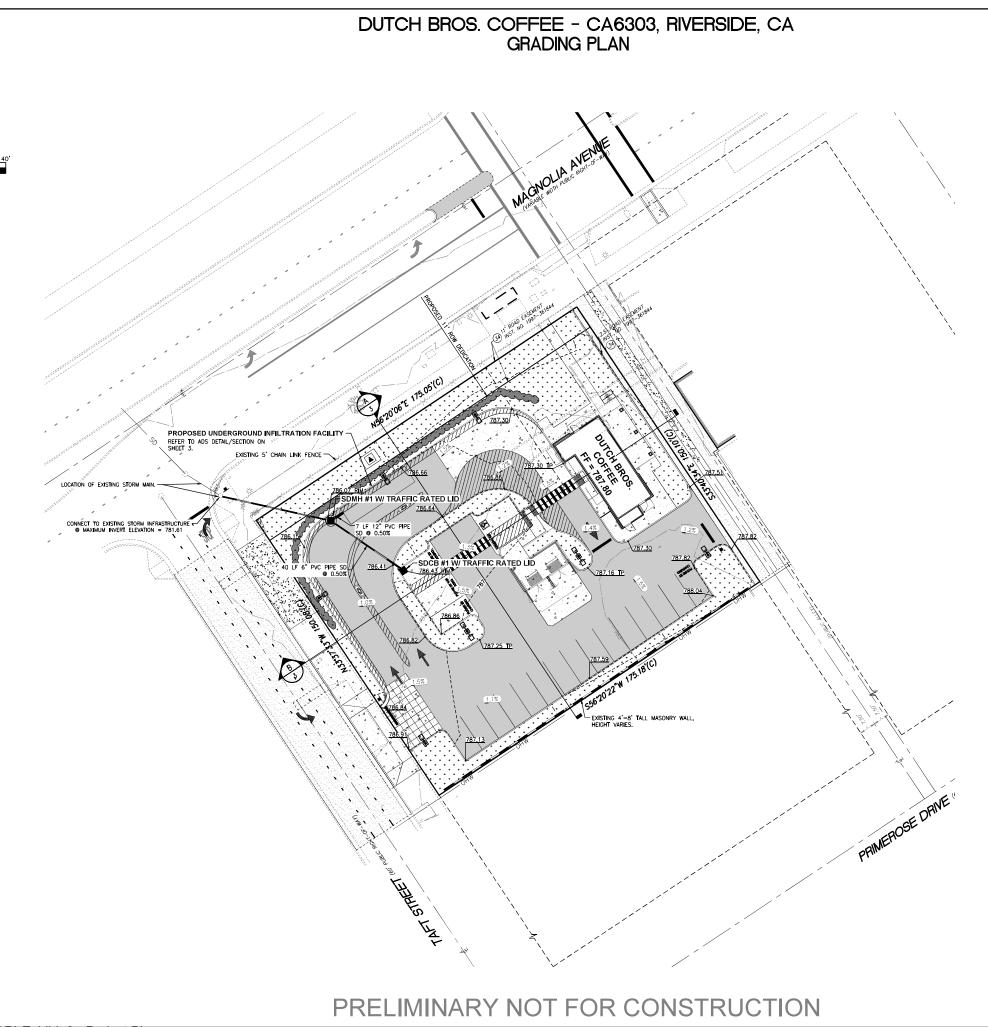


က Sheet 1 OF

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GRADING GENERAL NOTES:

- CONTRACTOR TO OBTAIN ANY NECESSARY RIGHT-OF-WAY PERMITS IF REQUIRED FOR WORK SHOWN ON PLANS.
- 6. CONTRACTOR SHALL MATCH EXISTING ELEVATIONS AT ALL SAWCUT LOCATIONS.
- ALL SPOT ELEVATIONS SHOWN ARE TO FINISH SURFACE (TOP OF ASPHALT OR TOP OF CONCRETE PAVEMENT, NOT TOP OF CURB/SIDEWALK) UNLESS OTHERWISE NOTED.

GRADING PLAN LEGEND:

EXISTING CONTOURS



LEGEND BUILDING LINE EXISTING CURB TO REMAIN PROPOSED CURB PROPOSED ASPHALT PROPOSED CONCRETE PROPOSED GRIND & OVERLAY

GRADING PLAN 9604 MAGNOLIA AVE RIVERSIDE, CA




HAL P. GRUBB AN OFFICE CONSTRUCTION




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គ្គី ទ្ធី| PR-2024-001679 (CUP, DR) Exhibit 8 - Project Plans

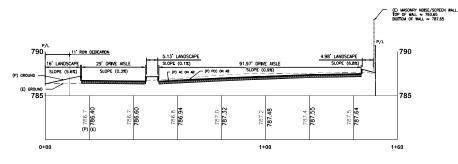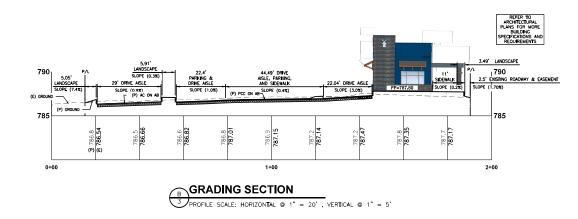DUTCH BROS. COFFEE - CA6303, RIVERSIDE, CA **GRADING SECTIONS**







<u>User Inputs</u>

Chamber Model: MC-3500 System Volume and Bed Size **Outlet Control Structure:** Nο Installed Storage Volume: 918.92 cubic ft. CA6303 Project Name: 109.90 cubic ft. Storage Volume Per Chamber: **Engineer:** N/A **Number Of Chambers Required: Project Location:** California Number Of End Caps Required: Measurement Type: Imperial 860 cubic ft. Required Storage Volume: Maximum Length: 34.42 ft. Stone Porosity: 40% **Maximum Width:** 8.42 ft. 9 in. Stone Foundation Depth: 289.67 square ft. Approx. Bed Size Required: Stone Above Chambers: 12 in. **System Components Average Cover Over Chambers:** 18 in (30 ft. x 80 ft.) **Design Constraint Dimensions:**


Amount Of Stone Required:	42 cubic yards
Volume Of Excavation (Not Including Fill):	60 cubic yards

Total Non-woven Geotextile Required: 141 square yards Woven Geotextile Required (excluding0 square yards Isolator Row):

<u>Results</u>

Woven Geotextile Required (Isolator 38 square yards Row):

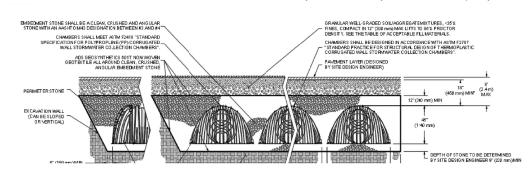Total Woven Geotextile Required: 38 square yards Impervious Liner Required: 0 square yards



GRADING SECTIONS 9604 MAGNOLIA AVE RIVERSIDE, CA



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Sheet
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PROJECT TEAM

LANDSCAPE ARCHITECT

EVERGREEN DESIGN GROUP 11801 PIERCE STREET, SUITE 200 RIVERSIDE, CA 92505 800-680-6630 WWW. EVERGREENDESIGNGROUP.COM
CONTACT: BLAKE TOMILLOSO-RHINEHART, PLA
EMAIL: BLAKE@EVERGREENDESIGNGROUP.COM

MULCHES

AFTER ALL PLANTING IS COMPLETE, CONTRACTOR SHALL INSTALL 3" THICK LAYER OF 1-1/2" SHREDDED WOOD MULCH, RECYCLED, NATURAL (UNDYED OVER LANDSCAPE FABRIC IN ALL PLANTING AREAS (EXCEPT FOR TURF AND SEEDED AREAS). CONTRACTOR SHALL SUBMIT SAMPLES OF ALL MULCHES TO LANDSCAPE ARCHITECT AND OWNER FOR APPROVAL PRIOR TO CONSTRUCTION, ABSOLUTELY NO EXPOSED GROUND SHALL BE LEFT SHOWING ANYWHERE ON THE PROJECT AFTER MULCH HAS BEEN INSTALLED (SUBJECT TO THE CONDITIONS AND REQUIREMENTS OF THE "GENERAL GRADING AND PLANTING NOTES" AND SPECIFICATIONS).

THE CONTRACTOR SHALL INSTALL ROOT BARRIERS NEAR ALL THE CONTRACTOR SHALL INSTALL ROOT BARRIERS NEAR ALL NEWL-YP-LANTED TREES THAT ARE LOCATED WITHIN FIVE (5) FEET OF PAVING OR CURBS. ROOT BARRIERS SHALL BE "CENTURY" OR "DEEP-ROOT" 24" DEEP PANELS (OR EQUAL), BARRIERS SHALL BE LOCATED IMMEDIATELY ADJACENT TO HARDSCAPE. INSTALL PANELS PER MANUFACTURER'S RECOMMENDATIONS. UNDER NO CIRCUMSTANCES SHALL THE CONTRACTOR USE ROOT BARRIERS OF A TYPE THAT COMPLETELY ENCIRCLE THE ROOTBALL.



DECLARATION OF WATER EFFICIENT LANDSCAPE ORDINANCE

I HAVE COMPLIED WITH THE CRITERIA OF THE WATER EFFICIENT LANDSCAPE ORDINANCE AND APPLIED SUCH CRITERIA FOR THE EFFICIENT USE OF WATER IN THE LANDSCAPE DESIGN PLAN.



EVERGREEN DESIGN GROUP 11801 PIERCE STREET, SUITE 200 RIVERSIDE, CA 92505

MWELO NOTES

- A DIAGRAM OF THE IRRIGATION PLAN SHOWING HYDROZONES SHALL BE KEPT WITH THE IRRIGATION CONTROLLER FOR SUBSEQUENT MANAGEMENT PURPOSES A CERTIFICATE OF COMPLETION SHALL BE
- FILLED OUT AND CERTIFIED BY EITHER THE IRRIGATION PLANS, OR THE LICENSED LANDSCAPE CONTRACTOR FOR THE
- PROJECT:
 3. AN IRRIGATION AUDIT REPORT BY A
 DISINTERESTED THIRD PARTY SHALL BE
 COMPLETED AT THE TIME OF FINAL
- COMPLETED AT THE TIME OF FINAL
 INSPECTION

 THE CONTRACTOR SHALL PREPARE A SOILS
 MANAGEMENT REPORT. THE SOIL
 MANAGEMENT REPORT SHALL BE BOTH
 INTEGRATED INTO THE PLANS AND
 SUBMITTED AS A SEPARATE DOCUMENT.
 PRESSURE REGULATING DEVICES ARE
 REQUIRED IF WATER PRESSURE IS BELOW
 OR EXCEEDS THE RECOMMENDED
 PRESSURE OF THE SPECIFIED IRRIGATION
 DEVICES,
 CHECK VALVES OR ANTI-DRAIN VALVES ARE
 REQUIRED ON ALL SPRINKLER HEADS
 WHERE LOW POINT DRAINAGE COULD
 OCCUR.

SOILS NOTE

FOR SOILS LESS THAN 6% ORGANIC MATTER IN THE TOP 6 INCHES OF SOIL, COMPOST AT A RATE OF A MINIMUM OF FOUR CUBIC YARDS PER 1.000 SQUARE FEET OF PERMEABLE AREA SHALL INTO THE SOIL EXCEPT WITHIN THE TPZ OF PROTECTED TREES, WHICH SHALL RECEIVE 4 - 6 OF HARDWOOD CHIP MULCH.

PLANT SCHEDULE

SYMBOL	CODE	BOTANICAL / COMMON NAME	SIZE	WUCOLS	CAL	HEIGHT		QTY
TREES								
*	AS	ARBUTUS UNEDO STRAWBERRY TREE	15 GAL	L	1.5" CAL.	6`-8`		3
0	CL	CHILOPSIS LINEARIS DESERT WILLOW	15 GAL	L	1.5" CAL.	6`-8`		2
\odot	QA	QUERCUS AGRIFOLIA COAST LIVE OAK	15 GAL	L	1.5" CAL.	6`-8`		2
SYMBOL	CODE	BOTANICAL / COMMON NAME	SIZE	WUCOLS	MATURE SIZE (W'XH')	ADDITIONAL	SPACING	QTY
SHRUBS								
*	AW	AGAVE WEBERI WEBER AGAVE	5 GAL	L			72" o.c.	8
Ó	AE	ARCTOSTAPHYLOS EDMUNDSII LĪTTLE SUR MANZANĪTA	1 GAL	L			60" o.c.	31
(*)	FN	FRANGULA CALIFORNICA 'EVE CASE' EVE CASE COFFEEBERRY	5 GAL	L			60" o.c.	45
$\widecheck{\bullet}$	MC	MUHLENBERGIA CAPILLARIS PINK MUHLY GRASS	1 GAL	L			42" o.c.	47
\odot	MD	MUHLENBERGIA DUBIA PINE MUHLY	1 GAL	L			36" o.c.	33
٨	SB	SENECIO MANDRALISCAE 'BLUE CHALK STICKS' SENECIO	1 GAL	L			36" o.c.	47
GROUND (COVERS							
	AG	3-5" CAMERON CREEK COBBLE 3" DEEP MIN, OVER FABRIC	-					963 SF
	BP	BACCHARIS PILULARIS 'PIGEON POINT' PIGEON POINT COYOTE BRUSH	1 GAL	L			36" o.c.	81

LANDSCAPE CALCULATIONS

PARKING LOT LANDSCAPE: PARKING SPACES: PARKING LOT TREES REQUIRED: PARKING LOT TREES PROVIDED:

5 TREES (1 TREE PER 4 SPACES) 5 TREES

DRIVE THROUGH SCREEN: 3' HEDGE PROVIDED

1. BY SUBMITTING A PROPOSAL FOR THE LANDSCAPE PLANTING SCOPE OF WORK, THE CONTRACTOR CONFIRMS THAT HE HAS READ, AND WILL COMPLY WITH, THE ASSOCIATED NOTES, SPECIFICATIONS, AND DETAILS WITH THIS PROJECT.

1. THE GENERAL CONTRACTOR IS RESPONSIBLE FOR REMOVING ALL EXISTING VEGETATION (EXCEPT WHERE NOTED TO REMAIN).

2. THE GENERAL CONTRACTOR IS RESPONSIBLE FOR REMOVING ALL EXISTING VEGETATION (EXCEPT WHERE NOTED TO REMAIN).

3. BEFORE STARTING WORK, THE LANDSCAPE CONTRACTOR SHALL VERIFY THAT THE ROUGH GRADES OF ALL LANDSCAPE AREAS ARE WITHIN \$4.0,1" OF FINISH GRADE. SEE SPECIFICATIONS FOR MORE DETAILED INSTRUCTION ON TUIL AREA AND PLANTING DED PREPARATION.
CONSTRUCT AND MAINTAIN FINISH GRADES AS SHOWN ON GRADING PLANS, AND CONSTRUCT AND MAINTAIN SLOPES AS RECOMMENDED BY THE GEOTECHNICAL REPORT. ALL LANDSCAPE AREAS SHALL HAVE POSITIVE DRAINAGE AWAY
FROM STRUCTURES AT THE MINIMUM SLOPE SPECIFIED IN THE REPORT AND ON THE GRADING PLANS, AND AREAS OF POTENTIAL PONDING SHALL BE REGRADED TO BLEND IN WITH THE SURROUNDING GRADES AND ELIMINATE PONDING

POTENTIAL.

O. THE LANDSCAPE CONTRACTOR SHALL DETERMINE WHETHER OR NOT THE EXPORT OF ANY SOIL WILL BE NEEDED, TAKING INTO ACCOUNT THE ROUGH GRADE PROWIDED, THE AMOUNT OF SOIL AMENDMENTS TO BE ADDED (BASED ON A SOIL TEST.) PER SPECIFICATIONS), AND THE FINISH GRADES TO BE ESTABLISHED,

d. ENSURE THAT THE FINISH GRADE IN SHRUB AREAS IMMEDIATELY ADJACENT TO WALKS AND OTHER WALKING SURFACES, AFTER INSTALLING SOIL AMENDMENTS, IS 3" BELOW THE ADJACENT FINISH SURFACE, IN ORDER TO ALLOW FOR PROPER MULCH DEPTH, TAPER THE SOIL SURFACE TO MEET FINISH GRADE, AS SPECIFIED ON THE GRADING PLANS, AT APPROXIMATELY 18" AWAY FROM THE WALKS.

e. ENSURE THAT THE FINISH GRADE IN TURE AREAS IMMEDIATELY ADJACENT TO WALKS AND OTHER WALKING SURFACES, AFTER INSTALLING SOIL AMENDMENTS, IS 1" BELOW THE FINISH SURFACE OF THE WALKS. TAPER THE SOIL SURFACE TO MEET FINISH GRADE, AS SPECIFIED ON THE GRADING PLANS, AT APPROXIMATELY 18" AWAY FROM THE WALKS.

f. SHOULD ANY CONFLICTS AND/OR DISCREPANCIES ARISE BETWEEN THE GRADING PLANS, GEOTECHNICAL REPORT, THESE NOTES AND PLANS, AND ACTUAL CONDITIONS, THE CONTRACTOR SHALL IMMEDIATELY BRING SUCH HEMST TO THE ATTENTION OF THE LANDSCAPE ARCHITECT, GENERAL CONTRACTOR, AND OWNER.

ALL PLANT LOCATIONS ARE DIAGRAMMATIC. ACTUAL LOCATIONS SHALL BE VERIFIED WITH THE LANDSCAPE ARCHITECT, GENERAL CONTRACTOR SHALL LOCATIONS SHALL BE VERIFIED WITH THE LANDSCAPE ARCHITECT OR DESIGNER PRIOR TO PLANTING. THE LANDSCAPE CONTRACTOR SHALL ENSURE THAT ALL REQUIREMENTS OF THE PERMITTING AUTHORITY ARE MET (I.E., MINIMUM PLANT QUANITIES, PLANTING METHODS, TREE PROTECTION METHODS, ETC.).

a. THE LANDSCAPE CONTRACTOR IS RESPONSIBLE FOR DETERMINING PLANT QUANITIES, PLANT QUAN

NO SUBSTITUTIONS OF PLANT MATERIALS SHALE BE ALLOWED WITHOUT THE WRITTEN PERMISSION OF THE LANDSCAPE ARCHITECT. IF SOME OF THE PLANTS ARE NOT AVAILABLE, THE LANDSCAPE ACCOUNTING THE LANDSCAPE ARCHITECT IN WRITING KIM PROPER CHANNELS. LANDSCAPE ARCHITECT IN WITHING (WA PROPER CHANNES).

THE CONTRACTOR SHALL AT A MINIMUM, PROVIDE REPRESENTATIVE PHOTOS OF ALL PLANTS PROPOSED FOR THE PROJECT. THE CONTRACTOR SHALL ALLOW THE LANDSCAPE ARCHITECT AND THE OWNER/OWNER'S REPRESENTATIVE.

TO INSPECT. AND APPROVE OR REJECT. ALL PLANTS DELIVERED TO THE JOBSITE. REFER TO SPECIFICATIONS FOR ADDITIONAL REQUIREMENTS FOR SUBMITTALS. THE CONTRACTOR SHALL MAINTAIN THE LANDSCAPE IN A HEALTHY CONDITION FOR 90 DAYS AFTER ACCEPTANCE BY THE OWNER. REFER TO SPECIFICATIONS FOR CONDITIONS OF ACCEPTANCE FOR THE START OF THE MAINTENANCE PERIOD AND FOR FINAL ACCEPTANCE AT THE END OF THE MAINTENANCE PERIOD.

SEE SPECIFICATIONS AND DETAILS FOR FURTHER REQUIREMENTS.

IRRIGATION CONCEPT

- 1. AN AUTOMATIC IRRIGATION SYSTEM SHALL BE INSTALLED AND OPERATIONAL BY THE TIME OF FINAL INSPECTION. THE ENTIRE IRRIGATION SYSTEM SHALL BE INSTALLED BY A LICENSED AND QUALIFIED IRRIGATION CONTRACTOR.

 2. THE IRRIGATION SYSTEM WILL OPERATE ON POTABLE WATER, AND THE SYSTEM WILL HAVE APPROPRIATE BACKFLOW PREVENTION DEVICES INSTALLED TO PREVENT CONTAMINATION OF THE POTABLE SOURCE.
- 3. ALL NON-TURF PLANTED AREAS SHALL BE DRIP IRRIGATED. SODDED AND SEEDED AREAS SHALL BE IRRIGATED WITH SPRAY OR ROTOR HEADS AT 100% HEAD-TO-HEAD COVERAGE
 4. ALL PLANTS SHARING SIMILAR HYDROZONE CHARACTERISTICS SHALL BE PLACED ON A VALVE DEDICATED TO PROVIDE THE NECESSARY WATER REQUIREMENTS SPECIFIC TO THAT
- 5. THE IRRIGATION SYSTEM SHALL BE DESIGNED AND INSTALLED. TO THE MAXIMUM EXTENT POSSIBLE, TO CONSERVE WATER BY USING THE FOLLOWING DEVICES AND SYSTEMS: MATCHED PRECIPITATION RATE TECHNOLOGY ON ROTOR AND SPRAY HEADS (WHEREVER POSSIBLE), RAIN SENSORS, AND MULTI-PROGRAM COMPUTERIZED IRRIGATION CONTROLLERS FEATURING SENSORY INPUT CAPABILITIES.





LANDSCAPE PLANTING 9604 MAGNOLIA A RIVERSIDE, CA

PLAN

BROS DUTCH













PRELIMINARY NOT FOR CONSTRUCTION

GENERAL

- ISSUEUD 1 IN SIZE OF CALFORNA'S CONTRACTOR STATE LICENSE BOARD.

 SOURCE OF WORK
 WORK COVERED BY THESE SECTIONS INCLUDES THE FURNISHING AND PAYMENT OF ALL MATERIALS,
 LABOR, SERVICES, ECLOPMENT, LICENSES, TAXES AND ANY OTHER THEMS THAT ARE NECESSARY FOR
 THE EXECUTION, INSTALLATION AND COMPLETION OF ALL WORK, SECRIFED HERBIT AND O'R SHOWN
 ON THE LANGEOVER PLANS, OTHERS AND DETAILS,
 REGULATIONS REQUIRED BY AUTHORITIES HAVING JURISDICTION OVER SUCH WORK, INCLUDING ALL
 INSPECTIONS AND PERMITS REQUIRED BY FEDERAL, STATE AND LOCAL AUTHORITIES IN SUPPLY,
 TRANSPORTATION AND INSTALLATION OF MATERIALS.

 THE LANDSCAPE CONTRACTOR SHALL VERIFY THE LOCATION OF ALL UNDERGROUND UTILITY LINES
 (WATER, SEWER, ELECTRICAL, TELEPHONE, GAS, CABLE, TELEMSION, ETC.) PRIOR TO THE STATT OF
 ANY WORK.

- ALL MANUFACTURED PRODUCTS SHALL BE NEW.
 CONTAINER AND BALLED-AND-SURFLAPPED PLANTS.
 CONTAINER AND BALLED-AND-SURFLAPPED PLANTS.
 BRANCHED HEALTHY, MOROODUS STOCK FREE OF DISEASE, INSECTS, EGGS, LARVAE, AND DEFECTS
 SUCH AS KNOTS, SUN SCALD, INJURIES, ABRASIONS, AND DISFIGUREMENT, ALL PLANTS WITHIN A
 SPECIES SHALL HAVE SIMLA SIZE, AND SHALLE BE OF A FORM TYPICAL FOR THE SPECIES, ALL TREES
 SHALL BE OBTAINED FROM SOURCES WITHIN 200 MLBS OF THE PROJECT STE, AND WITH SIMLAR
 CUMACTIC CONDITIONS.
 2. ROOT SYSTEMS SHALL BE HEALT BY, DENSELY PRANCHED BOOT SYSTEMS, NON-POTAGOUND, FREE
 STANDARD STANDARD

- 2. ROOT SYSTEMS SHALL BE HEALTHY, DENSELY BRANCHED ROOT SYSTEMS, NON-MULTOURNE, TREE
 FROM ENGICKING ANDOR GRIDLING ROOTS, AND FREE FROM ANY OTHER ROOT DEFECTS (SUCH AS
 JOHAPED ROOTS).

 JOHAPPED ROOTS,
 JOHANNEY BE ALEGEDED, BRANCHOST THRES ARE NOT ACCEPTABLE.

 ANY PLANT DESIRED, BRANCHOST THRES ARE NOT ACCEPTABLE.

 ANY PLANT DESIRED HONCEPTABLE BY THE LANDSCAPE ARCHITECT OR OWNER SHALL BE
 IMMEDIATELY REMOVED FROM THE SITE AND SHALL BE REPLACED WITH AN ACCEPTABLE HAND OF LIKE
 TYPE AND SIZE AT THE CONTRACTOR'S OWN EXPENSE, ANY PLANTS APPEARING TO BE UNHEALTHY.
 EVEN IN DETERMINED TO SHILL BE LIKE SHALL HOT BE ACCEPTED. THE LANDSCAPE ARCHITECT AND
 SIZE AT THE CONTRACTOR'S OWN EXPENSE, ANY PLANTS APPEARING TO BE UNHEALTHY.
 EVEN IN DETERMINED TO SHILL BE AS AND SHALL BY THE AND SHALL BE THE SHALL BE STANDARD IN FORM. JULESS OTHERWISE SPECIFIED, TREES WITH CENTRAL
 LEADERS WILL HOT BE ACCEPTED IF LEADER IS DAMAGED OR REMOVED, PRUNE ALL DAMAGED TWICE
 ACTION OF THE ACCEPTED AND SHALL BY THE AND SHALL BE AS FOLLOWS. SHINCHES
 AS THE REMOTE ALBERTS FOR STANDARD (SINGLE TRUNK) TREES SHALL BE AS FOLLOWS. SHINCHES
 HOWES ABOVE THE ROOT FLARE FOR TREES EXCEEDING FOUR INCHES IN CALIFER. AND TWELVE
 INCHES ABOVE THE ROOT FLARE FOR TREES EXCEEDING FOUR INCHES IN CALIFER.

 MULTITURINK TREES SHALL BE MEASUREMENTS ARE USED. THE CALIFER SHALL SO THAT
 THE ROOT BALL. WHERE CALIFER MEASUREMENTS ARE USED. THE CALIFER SHALL SO THAT
 THE ROOT FLARE HAS BEEN COMPLETELY COVERED. SHALL BE RECETED. TOOTS HALL SO THAT
 THE ROOT SAND WORN TO SOND THE OWN THE THE PROPERTY HAS BEEN COMPLETELY COVERED. SHALL BE RECETED.

 TOPSILL SHANDY TO CALY JOAN OF POSC, THESE OF THE THREE CREATE THAN IN NOT, HOT PORGEDIN MATTER.

 PLANTING, ROOTS, AND SEEDS.

 OUR SHALL SHAND THE CALIFER FOR THE SHALL BE RECETED.

 TOPSILL SHANDY TO CALY JOAN OF POSC, THESE OF O'S TROES LARGEST THAN IN NOT, HOT POSCHALL BE
 COMPOSED OF SUBSTANCES TO SHORT FOR THE THREE FOR CAMBOL MATTER.

 PLANTING, ROOTS, AND SEEDS.

 OUR SHALL SOND TO CALL FROM THE SHALL BE RECETED.

 TO SOLL SHANDY TO CA

- STAKES: IF LONG GREEN METAL T-POSTS. BUY AND TIE WIRE: ASTM A 641, CLASS 1, GALVANIZED-STEEL WIRE, 2-STRAND, TWISTED, 0.106 INCH
- 2. GUY AND TIE WIRE: ASTIM A B1, LUIADS 1, SUS-PARILLED STATE OF THE METERS OF THE MET

- OU. PREPARATION

 OU. PR
- SPALL BE REGRAZED TO BLEND IN WITH THE SURPOUNTAIND GROUPS AND CURRING THE EXPENSIVE POTENTIAL.

 THE LANDSCAPE CONTRACTOR SHALL DETERMINE WHETHER OR NOT THE EXPENT OF ANY SQL. WILL BE NEEDED, TAINNE NTO ACCOUNT THE ROUGH GRADE PROVIDED, THE AMOUNT OF SQL. AREXDIGHTORS OF THE AMOUNT OF SQL. AREXDIGHTORS, AND THE FIRST OF THE AMOUNT OF SQL. AREXDIGHTORS, AND THE FIRST OF THE FIRST GRADE IN SAFED, AND AMOUNT OF THE FIRST GRADE IN SAFED, AND AMOUNT OF THE FIRST GRADE IN SAFED AND AMOUNT OF THE FIRST GRADE IN SAFED AND AMOUNT OF THE FIRST GRADE IN SAFED AND AMOUNT OF THE AMOUNT OF
- TO MEET FINISH GRADE. AS SPECIFIED ON THE SHARLING PLANS, A LIFE CHANGE AS FOR THE WALKS.

 SHOULD ANY CONFLICT ANDOR DISCREPANCIES ARISE BETWEEN THE GRADING PLANS, GEOTECHNICAL REPORT. THESE NOTES AND PLANS, AND ACTUAL CONDITIONS. THE CONTRACTOR SHALL IMMEDIATELY BRING SUCH ITEMS TO THE ATTENTION OF THE LANDSCAPE ARCHITECT, GENERAL CONTRACTOR OF THE LANDSCAPE ARCHITECT, GENERAL CONTRACTOR SHALL ENSURE THAT THERE IN DEBRIS, TRASH, OR STONES LARGER THAN 1" REMAINING IN THE TOP 6" OF SOL.

- SUBMITTALS

 1. THE CONTRACTOR SHALL PROVIDE SUBMITTALS AND SAMPLES, IF REQUIRED, TO THE LANDSCAPE
 ARCHITECT, AND RECEIVE APPROVAL IN WRITING FOR SUCH SUBMITTALS SHEGRE WORK COMMEN

 2. SUBMITTALS SHALL INCLUDE PHOTOS OF PLANTS WITH A RULER OR HEASURING STICK FOR SCALE
 PHOTOS OR SAMPLES OF ANY REQUIRED WILLINGS, AND SOCI, TEST RESULTS AND PREPARATION
 RECOMMENDATIONS FROM THE TIST INGL LIS (NULLUM) COMPOST AND FERT PLIZER RATES AND
 TYPES, AND OTHER MEMBRIANTS FOR TRESPRUE, TUPE, AND SEED AREAS AS MAY BE

- RECOMMEDIATIONS FROM THE TESTING LAB INCLUDING COMPOST AND THEN INJECT MAN DE PROTYPES, AND OTHER AMENDMENTS FOR TREESTRIBL TURF, AND SEED AREAS AND YES
 APPROPRIATED.

 JUNITATION SEED AND THE COUNTY OF THE TOP THE TOP THE TOP TO THE TOP THE TOP

- ALL SEVERED ROOTS SHALL BE HAND PRUNED WITH SHAR DO NOT USE ANY SORT OF SEALERS OR WOUND PAINTS.
- DO NOT USE ANY SORT OF SEALENS OF WOUND PAPER.

 1. TREE PLANTING HOLES SHALL BE EXCAVATED TO MINMUM WIDTH OF TWO TIMES THE WIDTH OF THE ROOTBALL, AND TO A DEPTH EQUAL TO THE DEPTH OF THE ROOTBALL LESS TWO TO FOUR NOTES.

 2. SCANIFY THE SIDES AND BOTTOM OF THE PLANTING FROM THE PLANTING FOR THE THEE.

 3. SCANIFY THE SIDES AND BOTTOM OF THE PLANTING FROM THE PLANTING FOR THE PLANTING FOR THE THE PLANTING FROM THE ROOT DEFECTS. THE CONTRACTOR SHALL SHAVE A "LAYER OFF OF THE SIDES AND BOTTOM OF THE ROOTBALL OF ALL TREES JUST SEPORE PLANDING HIM TO BOY TEASE" ROOTS OUT FROM THE ROOTBALL OF ALL TREES AND STRONG FROM THE ROOTBALL SHAVE AND FROM THE ROOTBALL
- LIFECUS, ITE CONTINGUIDE SHALL BHAVE A 1" LAYER OFF OF THE SIDES AND BOTTOM OF THE ROOTBALL OF ALL TREES JUST BEFORE PLACING INTO THE PARTING PIT. DO NOT TEASE" ROOTS OF THE PROOTS OF

- WHEN PLANTING IS COMPLETE, INSTALL MULCH (TYPE AND DEPTH PER PLANS) OVER ALL PLANTING BEDS, COVERING THE ENTIRE PLANTING AREA
- ULCH

 MISTALL MULCH TOPDRESSING, TYPE AND DEPTH PER MULCH NOTE, IN ALL PLANTING AREAS AND
 TREE BY AND THE STATE OF THE STA
- EAN UP DURING LANDSCAPE PREPARATION AND PLANTING, KEEP ALL PAVEMENT CLEAN AND ALL WORK AREAS IN A NEAT, ORDERLY CONDITION, DISPOSED LEGALLY OF ALL EXCAVATED MATERIALS OFF THE PROJECT SITE. SPECTION AND ACCEPTANCE UPON COMPLETION OF THE WORK, THE LANDSCAPE CONTRACTOR SHALL PROVIDE THE SITE CLEAN, FREE OF DEBRÍS AND TRASH, AND SUTRIBLE FOR USE AS INTENDED. THE LANDSCAPE CONTRACTOR SHALL THEN ROUGHT AND AND SUTRIBLE FOR USE AS INTENDED. THE LANDSCAPE CONTRACTOR SHALL THEN REPORTED LAWTING WORKER TO DETERMINE FINAL ACCEPTAGILTY. WERE THE RESPONDED LAWTING WORKER OF SECTION TO THE OWNER TO DETERMINE FINAL ACCEPTAGITY. THE SATISFACTOR LAWTING WORK TO THE CONTRACT DOCUMENTS, THE SATISFACTORY WITH THE CONTRACT TO THE OWNERS.
- SHALL THEN REQUEST AN INSPECTION BY THE CONNEX OUT SELECTION THE CONTRACT DOCUMENTS, THE LANDSCAPE CONTRACTOR SHALL REPLACE ANDIOR REPAIR THE REJECTED WORK TO THE CONNEXS SATISFACTION MITH 14 HOURS.

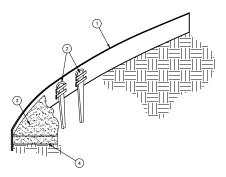
 THE LANDSCAPE MAINTENANCE PERIOD WILL NOT COMMENCE UNTIL THE LANDSCAPE WORK HAS BEEN REAR REPLACED BY THE COMMENT OF THE CONNEXS AND THE MAINTENANCE AND GUARANTER PERIODS WILL COMMENCE.

 THE LANDSCAPE MAINTENANCE SHALL BE RESPONSIBLE FOR THE MAINTENANCE AND GUARANTER PERIODS WILL COMMENCE.


 1. THE LANDSCAPE CONTRACTOR SHALL BE RESPONSIBLE FOR THE MAINTENANCE OF ALL WORK SHOWN ON THESE PLANS FOR BOAYS BEYOND FINAL ACCEPTANCE OF ALL LANDSCAPE WORK BY THE OWNER, AND COMPANY OF THE CONNEX, AND COMPANY OF THE COMPANY OF THE COMPANY OF THE MAINTENANCE OF ALL WORK SHOWN ON THESE PLANS FOR BOAYS BEYOND FINAL ACCEPTANCE OF ALL LANDSCAPE WORK BY THE OWNER, LANDSCAPE MAINTENANCE SHALL INCLUDE WEEKLY SITE WITS FOR THE FOLLOWING THAT HAS SETTLED WEEKING, TREATHS FOR THE FOLLOWING, THE MAINTENANCE SHALL INCLUDE WEEKLY SITE WITS FOR THE FOLLOWING. THAT HAS SETTLED WEEKING, TREATING FOR INSECTS AND DEBASES REPLACEMENT OF MULDICIPATION, REMOVAL OF LITTER, REPAIRS TO THE REGIGATION SYSTEM DUE TO FAULTY PARTS ANDOR WORKMANSHE, AND THE REPROPARTE WATERING OF ALL PLANTINGS. THE LANDSCAPE CONTRACTOR SHALL MAINTAIN THE IRRIGATION SYSTEM IN PROPER WORKING ORDER, WITH SCHOOL THE ADDRESS OF THE PROPERTION OF THE MAINTENANCE PERIOD.

 2. THE LANDSCAPE SHALL SHOW ACTION. HE MAINTENANCE PERIOD, ALL OF THE FOLLOWING CONDITIONS SHALL BE REJECTED AND REPLACED BY HEART BY SEASON LORMANCY, ALL PLANTS NOT MEETING THIS CONDITION SHALL BE REJECTED AND REPLACED BY HEART BY PLANT FOR THE MAINTENANCE PERIOD.

 3. THE LANDSCAPE SHALL SHOW ACTION. HEALT PLANT BY THE CONTRACTOR OF THE MAINTENANCE PERIOD. ALL OF THE FOLLOWING SYSTEMS FOR A PERIOD OF ONE YEAR FROM THE DATE OF THE CONTRACTOR OF THE MAINTENANCE PERIOD. THE LANDSCAPE FOR THE MAINTENANCE PERIOD OF THE CONNEX FOR THE LANDSCAPE PERIOD. THE LANDSCAPE FOR THE ADDRESS FREMILS. AND IRRIGATION SYSTEMS FOR



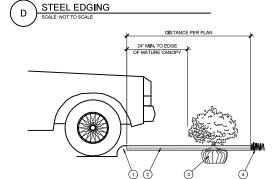
- 1 ROLLED-TOP STEEL EDGING PER PLANS.
- (2) TAPERED STEEL STAKES.
- 1) INSTALL EDGING SO THAT STAKES WILL BE ON INSIDE OF PLANTING BED.
 2) BOTTOM OF EDGING SHALL BE BURIED A MINMUM OF 1" BELOW FINISH OF
 3) TOP OF MULCH SHALL BE 1" LOWER THAN TOP OF EDGING.



- 2 MULCH LAYER.
 - (3) PLANT.

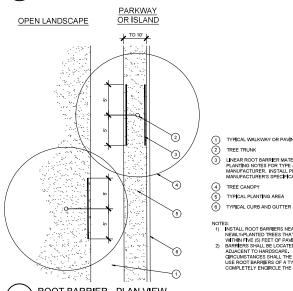 - 4 TURF (WHERE SHOWN ON PLAN).






- (1) TYPICAL WALKWAY OR PAVING TREE TRUNK

 - NOTES:

 1) INSTALL ROOT BARRIERS NEAR ALL
 NEWLY-PLANTED TREES THAT ARE LOCATED
 WITHIN THE OFFET OF PANIS OF CURES.

 2) THAT PIECE OF PANIS OF CURES.
 ADJACENT TO HARDSGAPE, LINDER NO
 GIRCUMSTANCES SHALL THE CONTRACTOR
 USE ROOT BARRIERS OF A TYPE THAT
 COMPLETELY ENGICLE THE ROOTBALL.
- ROOT BARRIER PLAN VIEW

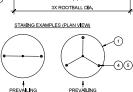PRELIMINARY NOT FOR CONSTRUCTION




TREE PLANTING

- (2) CINCH-TIES (24" BOX/2" CAL, TREES AND SMALLER) OR 12 GAUGE GALVANIZED MIRE WITH NYLON TREE STRAPS AT TREE AND STAKE (80" BOX/2.5" CAL, TREES AND LARGET), SECURE ITES OR STRAPS TO TRUNK JUST ABOVE LOWEST MAJOR BRANCHES
- (3) 24" X 3/4" P.V.C. MARKERS OVER WIRES.
- GREEN STEEL T-POSTS. EXTEND POSTS 12" MIN. INTO UNDISTURBED SOIL.
- (5) PRESSURE-TREATED WOOD DEADMAN, TWO PER TREE (MIN.). BURY OUTSIDE OF PLANTING PIT AND 18" MIN. INTO UNDISTURBED SOIL.
- MULCH, TYPE AND DEPTH PER PLANS. DO NOT PLACE MULCH WITHIN 6" OF TRUNK.
- (8) FINISH GRADE.
- 9 ROOT BALL.
- 10 BACKFILL, AMEND AND FERTILIZE ONLY AS RECOMMENDED IN SOIL FERTILITY ANALYSIS. (11) UNDISTURBED NATIVE SOIL.
- (12) 4" HIGH EARTHEN WATERING BASIN.
- (13) FINISH GRADE.
- NOTES:


 1. SOARIPY SIDES OF PLANTING PIT PRIOR TO SETTING TREE.

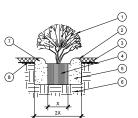 2. REMOVE EXCESS SOLL APPLED ON TOP OF THE ROOTBALL THAT COVERS THE ROOT LARE. HE PLANTING HOLE DEPTH SHALL BE ROOTBALR THAT COVERS THE ROOT LARE. HE PLANTING HOLE DEPTH SHALL BE ROOTBALR STATE OF THE ROOTBALR STATE STATE STATE OF THE ROOTBALR STATE STATE ALL THUS IT IS. SHALL STATE OF THE ROOTBALR STATE STATE ALL THUS IT IS. SHALL STATE OF THE ROOTBALR STATE STATE ALL THUS IT IS. SHALL STATE OF THE ROOTBALL AS IT IS THE STATE OF THE ROOTBALL STATE OF THE STATE OF THE ROOTBALL STATE OF THE STATE OF THE STANE OF TH



- (2) MULCH, TYPE AND DEPTH PER PLANS. PLACE NO MORE THAN 1° OF MULCH WITHIN 6° OF PLANT CENTER.
- 3 FINISH GRADE. (4) ROOT BALL.
- BACKFILL, AMEND AND FERTILIZE ONLY AS RECOMMENDED IN SOIL FERTILITY ANALYSIS. (6) UNDISTURBED NATIVE SOIL.

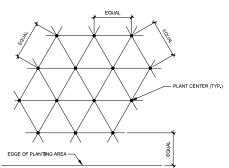SHRUB AND PERENNIAL PLANTING



NOTE: ALL PLANTS SHALL BE PLANTED AT EQUAL TRIANGULAR SPACING (EXCEPT WHERE SHOWN ON PLANS AS INFORMAL GROUPINGS). REFER TO PLANT LEGEND FOR SPACING DISTANCE BETWEEN PLANTS.



2) STEP 2: SUBTRACT THE ROW (S) OF PLANTS THAT WOULD OCCUR AT THE EDGE OF THE PLANTED AREA WITH THE FOLLOWING FORMULA: TOTAL PERIMETER LENGTH / PLANT SPACING = TOTAL PLANT SUBTRACTION EXAMPLE: PLANTS AT 18" O.C. IN 100 SF PLANTING AREA, 40 LF PERIMETER
STEP 1: 100 SF/1.95 = 51 PLANTS
STEP 2: 51 PLANTS (40 LF / 1.95 = 21 PLANTS) = 30 PLANTS TOTAL

PLANT SPACING



LANDSCAPE PLANTING SPECIFICATIONS & DETAILS 9604 MAGNOLIA AVE RIVERSIDE, CA







Engineer nue South

Barghausen Consulting El 18215 72nd Avenu Kent, WA 98032 425.251.6222



2

CODE SUMMARY

BUILDING CODE 2022 CBC
MECHANICAL CODE 2022 CMC
PLUMBING CODE 2022 CPC
ENERGY CODE 2022 CAL ENERGY CODE
CAL GREEN 2022 CAL GREEN
FIRE CODE 2022 CFC
ELECTRICAL CODE 2022 CFC
ACCESSIBILITY CODE 2022 CBC
ACCESSIBILITY CODE 2022 CBC CHAPTER 11B
ALL CODES SHALL INCLUDE CITY OF RIVERSIDE AMENDMENTS

SITE DATA

ZONING: GC SITE AREA: 26,285 S.F. CLIMATE ZONE: WATER FILTRATION SYSTEM: SYSTEM 3

BUILDING CONSTRUCTION DATA

CONSTRUCTION TYPE PROPOSED BUILDING HEIGHT: PROPOSED STORIES: TOTAL FLOOR AREA: MAXIMUM ALLOWABLE AREA: 950 S.F. GROSS 6,000 S.F.

FIRE-RESISTANCE RATING FOR STRUCTURAL ELEMENTS: (PER CBC TABLE 601) 0 HOURS

BUILDING OCCUPANCY DATA

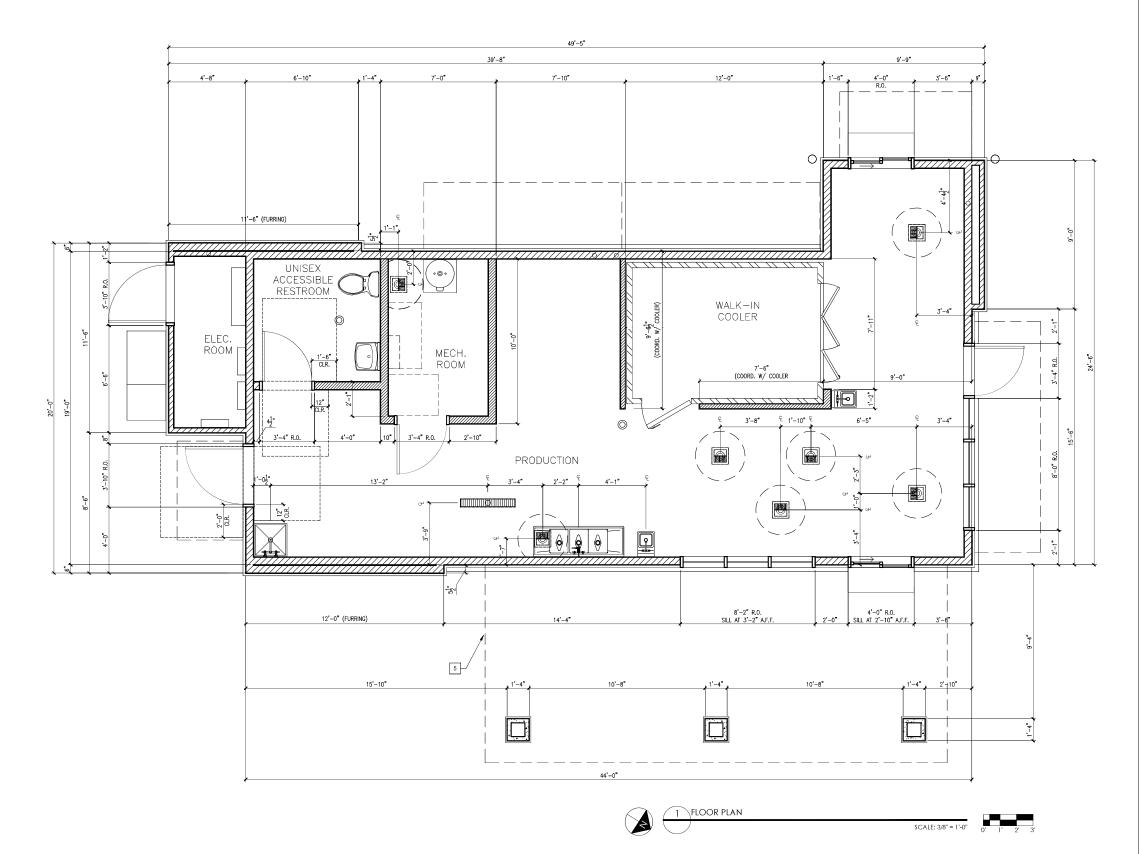
OCCUPANCY CLASSIFICATION: (RESTAURANT) GROUP B 49 OCCUPANTS MAX. 950 S.F. 1/150 6.33

GROSS AREA: LOAD FACTOR: OCCUPANT LOAD: TOTAL OCCUPANT LOAD:

EXITS: TOTAL EXITS:

7 (OCCUPANT LOAD) X .2" / PERSON: EXIT WIDTH PROVIDED: 1.40 INCHES 40 INCHES

MAXIMUM EXIT ACCESS TRAVEL DISTANCE: 75 FEET RESTROOM FACILITIES PER CPC TABLE 422.2 1 LAVATORY PROVIDED 1 WATER CLOSET PROVIDED





ARMÉT DAVIS NEWLOVE & ASSOCIATES, AIA ARCHITECTS



CA6303 New Freestanding Store Project No: (Dutch Bros Coffee - No. 2550 - A2 PROTOTYPE 9604 MAGNOLIA AVE. RIVERSIDE, CA 92503

DATE: 01/09/2024

FLOOR PLAN/ DETAILS/ SCHEDULES

SHEET NUMBER:

A2.0





ARMÉT DAVIS NEWLOVE & ASSOCIATES, AIA ARCHITECTS



Oject No: CA6303 tch Bros Coffee - New Freestanding Store 50 - A2 PROTOTYPE


Project No:	Dutch Bros Coffee -	2550 A 2 DECITATIVE	2300 - A2 F NO 10 11 F L	9604 MAGNOLIA AVE.	RIVERSIDE, CA 92503
DATE:	01/09	/20	024		
REV: D	DATE:		DESC	RIPTIC	N:
SHEE	TNAN	ΛF·			

ROOF PLAN/ ROOF

DETAILS SHEET NUMBER:

A4.0

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INSTALLED BY SIGN CONTRACTOR, COORDINATE WITH ELECTRICAL J-BOX AND BLOCKING REQUIREMENTS

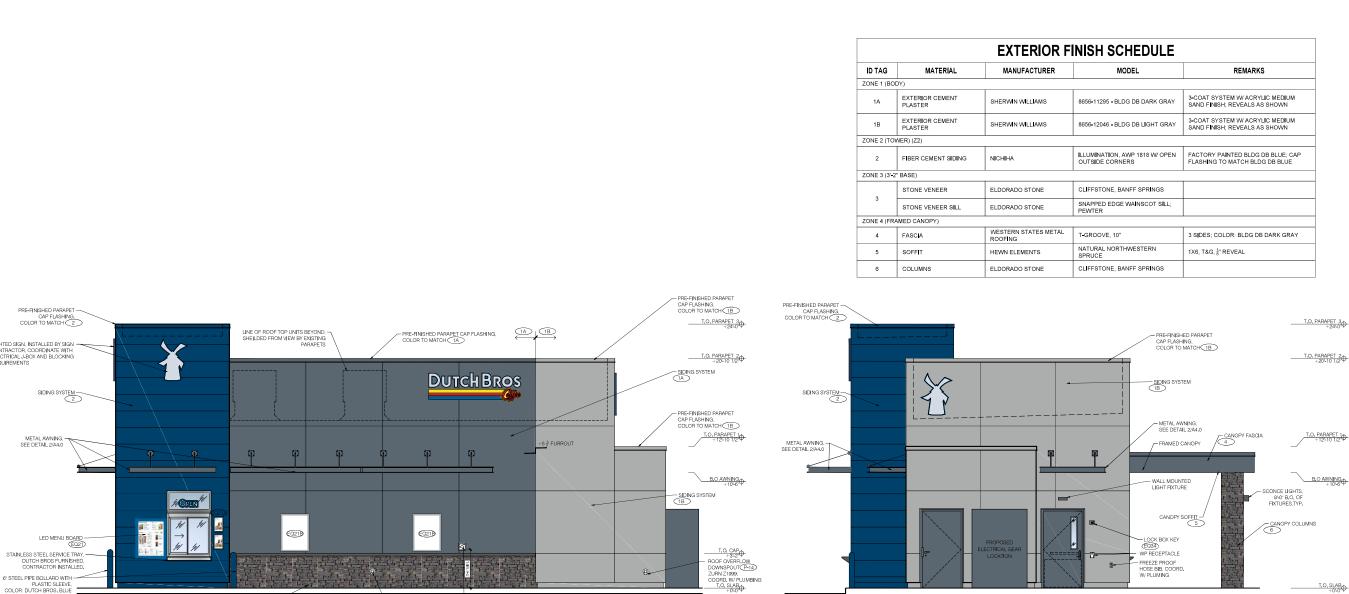T.O. CANOPY

B,O AWNING +1046

T.O. SERVICE

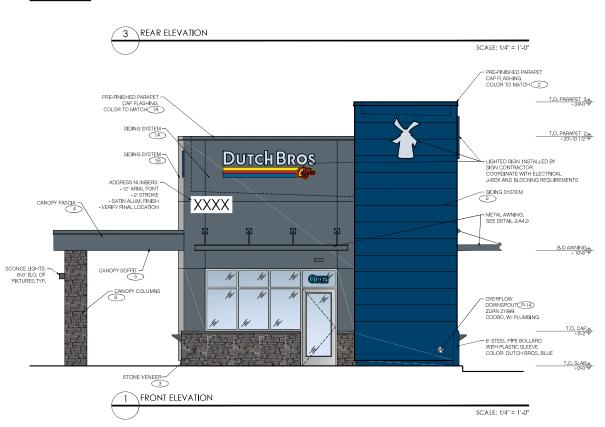
COUNTER +2'-10'

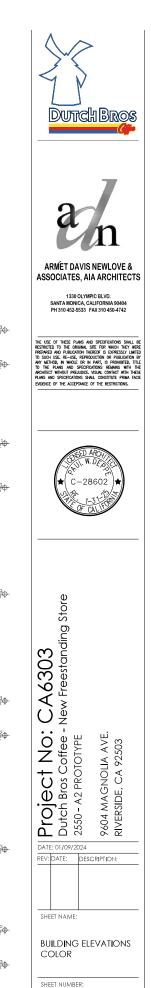
T.O. SLAB

SCALE: 1/4" = 1'-0"

SCALE: 1/4" = 1'-0"

DUTCH BROS





A6.1

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PRE-FINISHED PARAPE

PRE-FINISHED PARAPET -CAP FLASHING, COLOR TO MATCH 1B

METAL AWNING, -SEE DETAIL 2/A4.0

RNAL CANOPY ROOF D REFER TO A3.1 & A4.0 ADDITIONAL INFORMA 4 ELEVATION - DRIVE-THRU WINDOW

2 ELEVATION - WALK-UP WINDOW

SIDING SYSTEM TA

LINE OF ROOF TOP UNITS BEYOND, SHEILDED FROM VIEW BY EXISTING PARAPETS

(IB) (IA)

+5½ FURROU



FIBER CEMENT SIDING AT TOWER NICHIHA - ILLUMINATION AWP-1818 COLOR: DUTCH BROS BLUE



STONE VENEER AT WAINSCOT & COLUMNS ELDORADO STONE - CLIFFSTONE COLOR: BANFF SPRINGS



EXTERIOR CEMENT PLASTER AT BUILDING SHERWIN WILLIAMS - 8656-12046 COLOR: DUTCH BROS LIGHT GRAY



WAINSCOT SILL ELDORADO STONE - SNAPPED EDGE COLOR: PEWTER



EXTERIOR CEMENT PLASTER AT BUILDING, CANOPY FASCIA & METAL AWNINGS SHERWIN WILLIAMS - 8656-11295 COLOR: DUTCH BROS DARK GRAY

18 GA METAL DECK; PER PLAN TS 3" x 2" x 1/4" STD STEEL, WELD ALL JOINTS & GRIND SMOOTH 3" x 2" x 1/4" STD, STEEL ANGLE WELD ALL JOINTS & GRIND SMOOTH (3) GALVANIZED STEEL HINGE COLLARS W/ GREASE FITTINGS WELD TO GATE ANGLE FRAMING PAINT PER PLAN ROUND CONCRETE TOP, PAINT PER PLAN 6° DIA GALVANIZED PIPE GATE POST, FILL SOLID WITH CONCRETE, PAINT PER PLAN CONCRETE CAP 3" X 1/4" STEEL PLATE WELDED TO METAL DECK (3) STEEL HINGE COLLARS - W/ GREASE FITTING; WELD TO GATE ANGLE FRAMING; PAINT PER PLAN TS INTERMEDIATE 3" x 2" x 1/4" STD. STEEL FRAME; WELD ALL JOINTS GRIND SMOOTH TOTOTO . 000000 (3) STEEL HINGE RETAIN SLEEVE WELDED TO STEEL GATE POST CONCRETE FOOTING, REFER TO STRUC, FOR REINFORCEMI 1/2" EXPANSION JOINT CONCRETE DUMPSTER PAD - OVER GAVEL SLOPE TO DRAIN; REFER TO STRUCTURAL SHEETS 1'-6" 5 BOLLARD DETAIL SCALE: 1/2" = 1'-0" 2 TRASH ENCLOSURE GATE JAMB DETAIL 6" CURB AS OCCURS -SEE PLAN PRE-MANUFACTURED METAL GATE HANDLES 4" 3000 PSI CONC, SLAB - 7/8" STEEL ROD - SLIDE STOP TAB - 1 1/2" X 1/4" FLAT STOCK - LOCK TAB 6 TRASH ENCLOSURE SECTION SCALE: 1/2" = 1'-0" CANE BOLT "HOLD-OPEN" TABS 3 TRASH ENCLOSURE GATE LOCKING HANDLE - CMU, PER PLAN W/ SOLID GROUT AND REINFORCING PER STRUCTURAL SCALE: 1-1/2" = 1'-0" - (3) STEEL HINGE COLLARS W/ GREASE FITTINGS, WELD TO GATE ANGLE FRAMING, PAINT PER PLAN - (3) STEEL HINGE COLLARS W/ GREASE FITTINGS, WELD TO GATE ANGLE FRAMING, PAINT PER PLAN 6" DIA, HSS GATE POST FILL SOLID WITH CONCRETE, EMBED 3"-0" INTO CONC. FTG. PAINT PER PLAN (2) 6" DIA. PIPE GATE POST FILL SOLID W/ CONCRETE, EMBED 3"-0" INTO CONC. FTG. PAINT PER PLAN A'' x 2" x 1/4" STD. STEEL ANGLE, WELD ALL JOINTS & GRIND SMOOTH, PAINT PER PLAN 3" x 2" x 1/4" STD, STEEL ANGLE, WELD ALL JOINTS & GRIND SMOOTH 3" x 2" x 1/4" HSS FRAME, WELD ALL JOINTS & GRIND SMOOTH, PAINT PER PLAN - TS 3" x 2" x 1/4" STD STEEL, WELD ALL JOINTS & GRIND SMOOTH METAL SIDING TO MATCH BUILDING 7 TRASH ENCLOSURE GATE JAMB DETAIL 4 TRASH ENCLOSURE GATE JAMB DETAIL

TRASH ENCLOSURE GENERAL NOTES:

4'-0 1/2"

= 6"H x 6"W CONC, CURB AT SIDES OF TRASH ENCLOSURE, TYP. 9

PROVIDE METAL SLEEVES IN CONC. APRON FOR GATE CANE ANCHORS, TYP.

PROVIDE METAL SLEEVES

1'-6" TYP.

6' METAL BOLLARD FILLED W/ CONC.

4 A9.0

PROVIDE METAL SLEEVES -IN CONC. APRON FOR GATE CANE ANCHORS, TYP.

YARD HYDRANT LOCATION PROVIDE 3/4" WATER LINE, COORD, W/ PLUMBING

SIM. A9.0

3 A9.1

7 A9.0

1. REFER TO STRUCTURAL FOR MASONRY, CONCRETE, STRUCTURAL STEEL AND REINFORCING STEEL FOR SPECIFICATIONS.

NE NE

DUMPSTER BY REFUSE SERVICE PROVIDER

PROVIDE METAL SLEEVES IN -CONC. APRON FOR GATE CANE ANCHORS, TYP.

1 TRASH ENCLOSURE PLAN

8'x16'x8' SPLIT CMU WALLS W/ 12'x16'x2' CMU CAP

6"H x 6"W CONC. CURB AT SIDES OF TRASH ENCLOSURE. TYP.

(2) 5'-4" x 5'-8" STEEL GATES, W/ 6" DIA, HSS GATE POST, FILLED W/ CONC.; EMBED 36" INTO CONC, FTG.

SCALE: 1/2" = 1'-0"

- 2. PROVIDE LOCKING MECHANISM ON GATES AND PEDESTRIAN GATE.
- 3. PROVIDE SITE LIGHTING AT TRASH ENCLOSURE. MIN. 5 FOOT CANDLE.
- 4. GATE TO BE BUILT WITH 3"X 2" SQUARE STEEL TUBING WITH ALL JOINTS FULLY WELDED TOGETHER AND 1 CROSS MEMBER PER GATE, FRAME TO BE PRIMED AND PAINTED PER PLAN.





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Freestanding Store CA6303 Project No: (Dutch Bros Coffee - N 2550 - A2 PROTOTYPE

9604 magnolia ave. Riverside, ca 92503 DATE: 01/09/2024

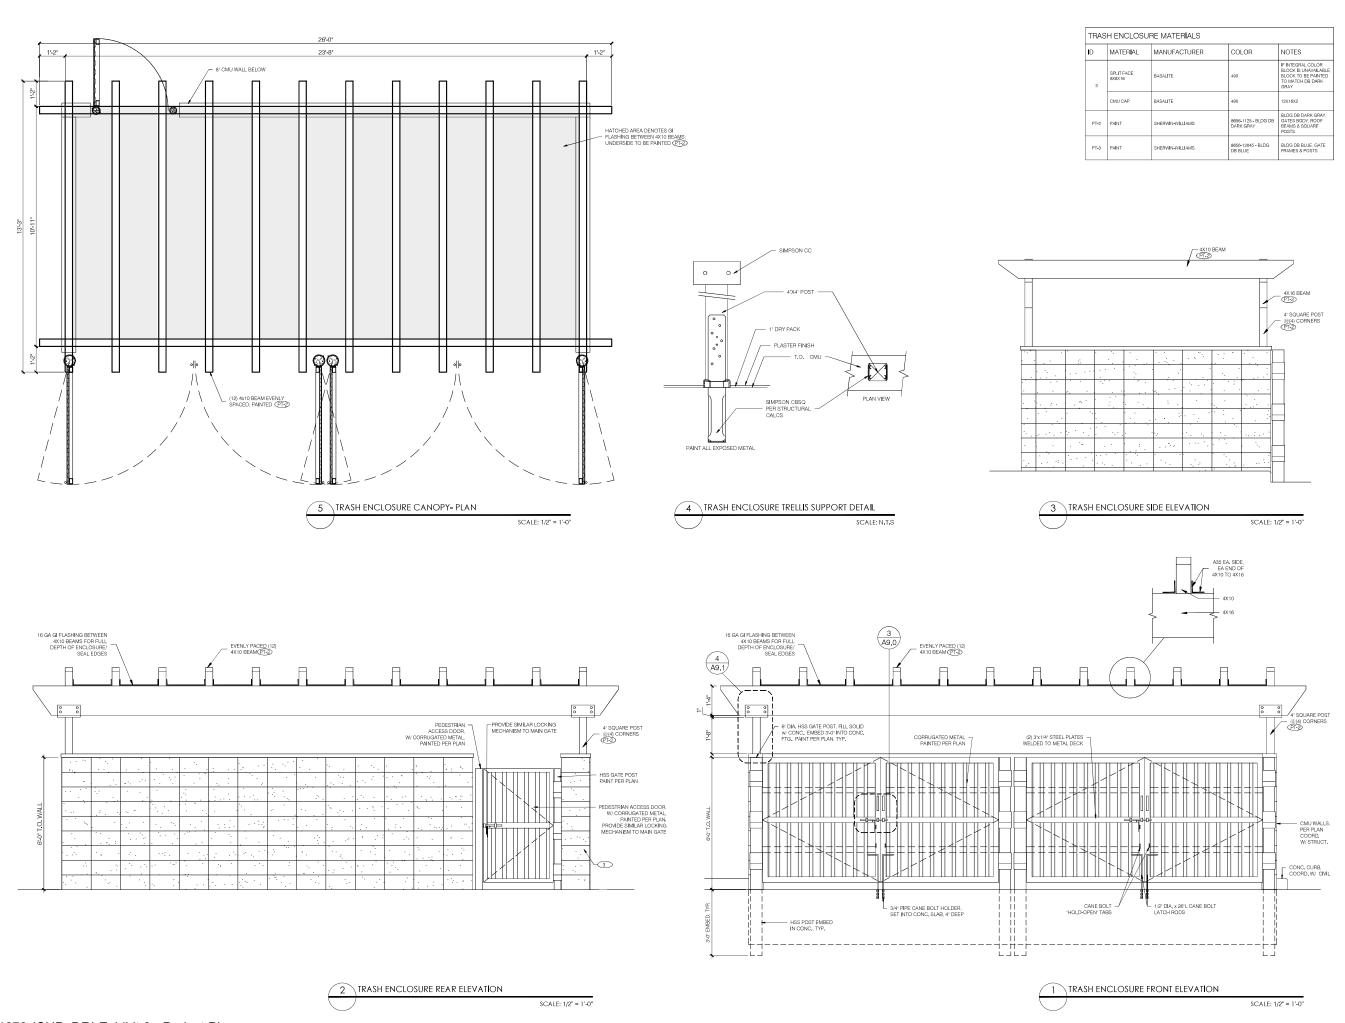
SHEET NAME:

TRASH ENCLOSURE PLAN/ ELEVATIONS

SHEET NUMBER:

A9.0





Dutch Bros

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Project No: CA6303

Dutch Bros Coffee - New Freestanding Store
2550 - A2 PROTOTYPE


9604 MAGNOLIA AVE.
RIVERSIDE, CA 92503 DATE: 01/09/2024


REV: DATE: DESCRIPTION: SHEET NAME:

TRASH ENCLOSURE PLAN/ ELEVATIONS

SHEET NUMBER:

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1) ELECTRICAL PHOTOMETRIC PLAN
SCALE: 1" = 20"-0"

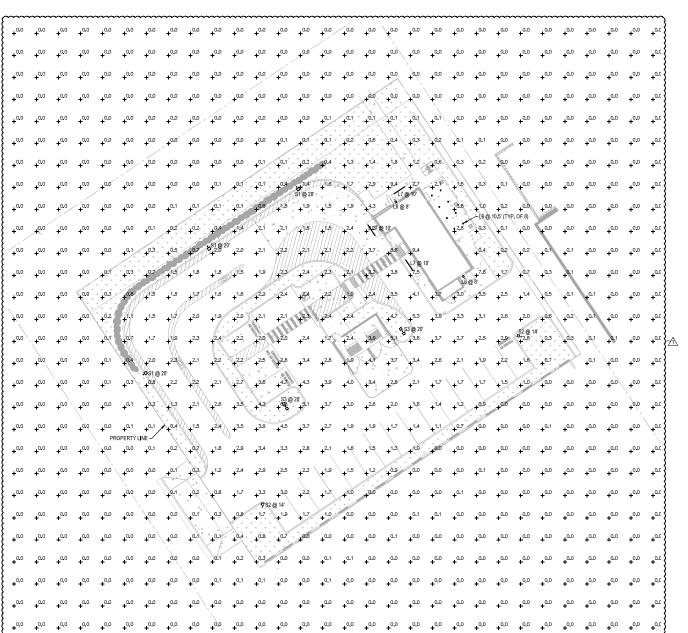DESCRIPTION	SYMBOL	AVE	MAX	MIN	MAX/MIN	AVE/MIN	
DRIVE THRU	+	2.4 fc	9.3 fc	1.3 fc	7.21	1.8:1	
GENERAL HARDSCAPE	+	2.1 fc	9.4 fc	0.0 fc	N/A	N/A	
PARKING & DRIVEWAY	+	2.5 fc	5.7 fc	1.0 fc	5.7:1	2.5:1	
TRASH ENCLOSURE	+	3.2 fc	3.9 fc	2.4 fc	1,6:1	13:1	

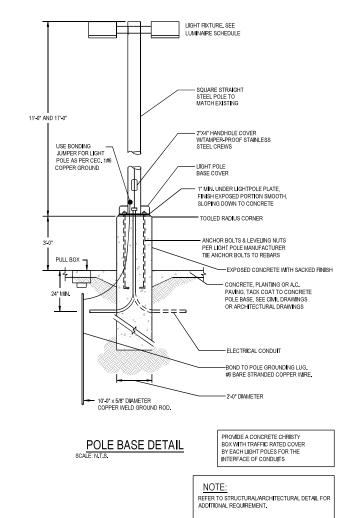SCHEDU	ILE								
SYMBOL	LABEL	QUANTITY	MANUFACTURER	CATALOG NUMBER UNDER CANOPY OR BUG RATING	DESCRIPTION	NUMBER OF LAMPS	LUMENS PER LAMP	LIGHT LOSS FACTOR	WATTAGE
â	L6	2	RAB LIGHTING INC.	WPLED26Y-WPLED26Y/D10 (WALLPACK) - ALED26Y-ALED26Y/D10 (AREA LIGHTER) (UNDER CANOPY)	CAST FINNED METAL HOUSING, MOLDED PLASTIC REFLECTOR WITH SEMI-SPECULAR FINISH B1-U0-G1	1	3295	0.72	29.70
_	L7	4	SELF	CROWN-L144-120V 830_BA110 (UNDER CANOPY)	CROWN-L144-120V 830_BA110	1	6300	0.72	60
0	L9	8	DMF LIGHTING	DRD5S-4R-07930 (UNDER CANOPY)	DRD5S-4R-07930	1	757	0.72	8.37
Ģ	S1	3	NLS LIGHING LLC	NV-1-T4-32L-7-30K7-HSS (BUG RATING: B0 - U0 - G1)	NV SERIES AREA LIGHTING FIXTURE WITH HSS	1	5081	0.72	71
Ġ	\$2	2	NLS LIGHING LLC	NV-1-T4-16L-7-30K-UNV (BUG RATING: B1 - U0 - G1)	NV SERIES AREA LIGHTING FIXTURE	1	3973	0,72	36
0.0	\$3	2	NLS L I GH I NG LLC	NV-1-T4-48L-7-30K-UNV (BUG RATING: B2 - U0 - G2)	NV SERIES AREA LIGHTING FIXTURE	2	11331	0.72	208



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ACIES
ENGINEERING
400 N. McCarthy Blvd., Suite 250
Millpitas CA, 95035
oh: (400)527-5255 I fs: (400)522-52



Freestanding Store CA6303 New Freestandi Project No: (Dutch Bros Coffee - N 2550 - A2 PROTOTYPE

9604 magnolia ave. Riverside, ca 92503 DATE: 01/09/2024

05/31/24 PLANNING PCC #1

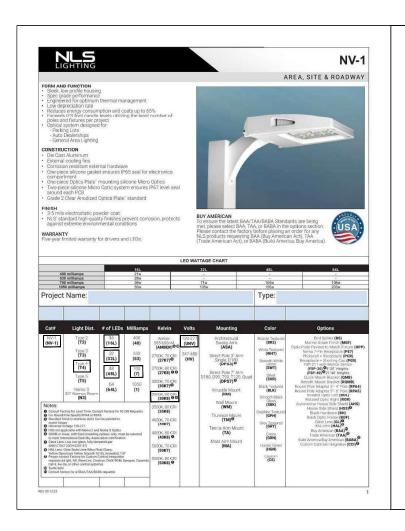
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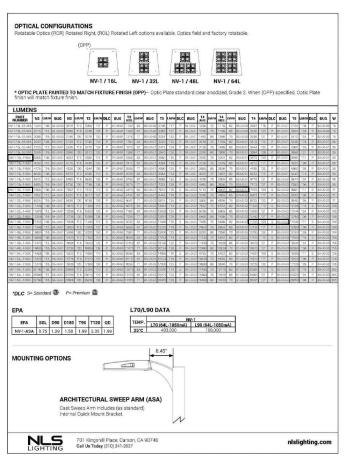
PHOTOMETRIC SITE PLAN

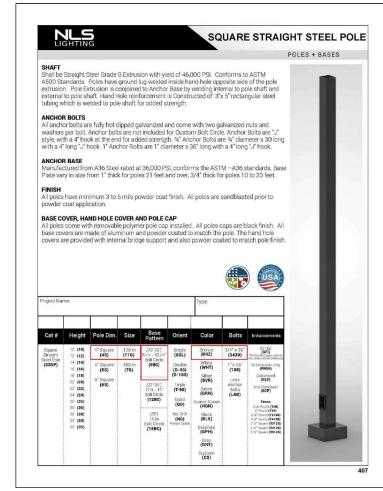
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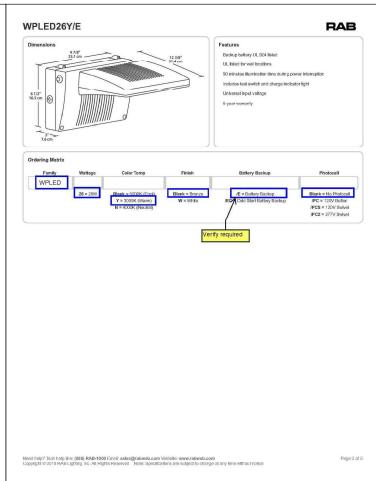
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ACTES ENGINEERING 400 N. McCarthy Blvd., Suite 250 Milipitas CA, 96035 ph: (408)522-5255 | fx: (408)522-524



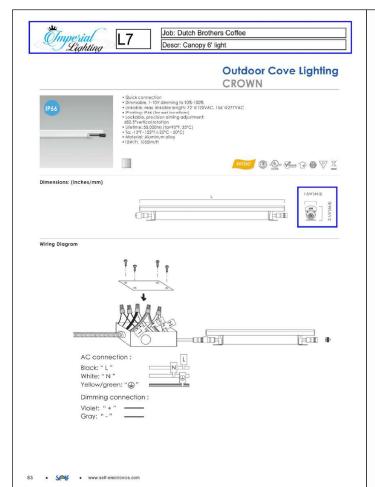
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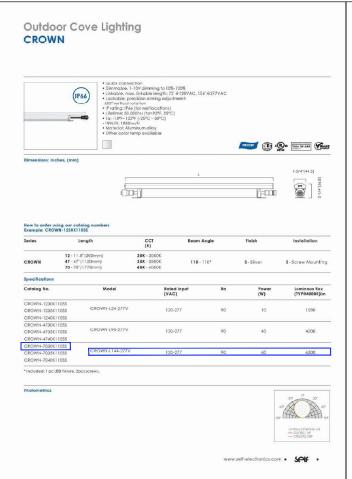
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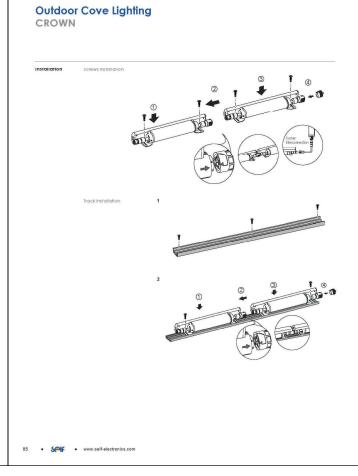
CUTSHEETS


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CA6303 New Freestanding Store Project No: (Dutch Bros Coffee - N 2550 - A2 PROTOTYPE 9604 magnolia ave. Riverside, ca 92503 DATE: 01/09/2024 05/31/24 PLANNING PCC #1 SHEET NAME:

EXTERIOR LIGHTING

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CUTSHEETS

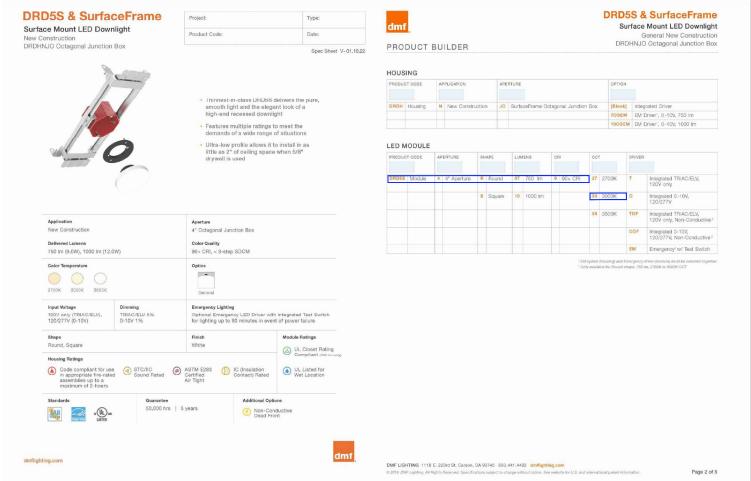SHEET NUMBER: