# DUNCAN GARDENS

#### **CODE DESCRIPTION:**

ALL PLANS & INFORMATION HEREIN SHALL COMPLY WITH:

2019 CALIFORNIA BUILDING CODE

2019 CALIFORNIA RESIDENTIAL CODE

2019 CALIFORNIA ELECTRICAL CODE

2019 CALIFORNIA MECHANICAL CODE

2019 CALIFORNIA PLUMBING CODE

2019 CALIFORNIA FIRE CODE

2019 CALIFORNIA ENERGY CODE 2019 BUILDING ENERGY EFFICIENCY STANDARDS

#### **PROJECT SCOPE:**

PROPOSAL OF NEW CONSTRUCTION OF (2) BUILDINGS TOTALING 9,104 SQ. FT. TRIPLEX/CONDO BUILDINGS. EACH BUILDING CONTAINING (3) UNITS MITH 3 BEDROOMS, 2-1/2 BATHROOMS AND A 2 CAR GARAGE ON A VACANT PROPERTY WITH OFF-SITE PARKING. RETAINING BLOCK WALLS TO BE ADDED TO THE SIDES OF THE PROPOSED PROJECT LOT

#### **CITY/COUNTY UTILITIES:**

WATER (PROPOSED) ELECTRIC (PROPOSED)

TELEPHONE (PROPOSED) DISPOSAL (PROPOSED)

GAS (PROPOSED) SEWER (PROPOSED)

## **WATER EFFICIENCY SCHEDULE:**

FIXTURE TYPE MAXIMIJM FI,OW RATE SHOWER HEAD 2.0 GPM @ 80 PSI KITCHEN FAUCET 1.8 GPM @ 60 PSI LAVATORY FALICET 1.2 GPM @ 60 PSI WATERCI OSET 1 28 GPF

#### PROPOSED LAND COVERAGE:

AREA	SQ. FT.	COVERAGE
BUILDING AREA FOOTPRINT:	5,398.97	25%
CONCRETE:	10,912.64	51%
LANDSCAPING:	4.825.48	24%
TOTAL NET LAND AREA COVERAGE:	21.197.09	100%

AREA BETWEEN BUILDING:

NO PROTECTED PLANTS ON SITE

55'-10" 40'-10" × 55'-10"

#### **LEGAL DESCRIPTION:** 191-200-028

ADDRESS: 9321 DUNCAN AVENUE RIVERSIDE, CA 925036 SITE DESCRIPTION 48 ACRES NET IN PAR 2 Pm 223/004 Pm 30874

OCCUPANCY: TYPE:

MULTI-FAMILY RESIDENCE

OCCUPANCY LOAD: <10 SPRINKLER YES STORIES:





# **PROJECT TEAM**

LANDSCAPE:

ARCHITECTURAL: JONATHAN L. ZANE ARCHITECTURE

RICHARDS DESIGN GROUP ANDREW RICHARDS PAUL A. CROSBY CONSULTING ENGINEER

PAUL CROSBY

CONSTRUCTION JOHNNY VII STRUCTURAL:

PAUL A. CROSBY

CONSULTING ENGINEER

GEOTECHNICAL: TANA ENGINEERS. INC BLADIMIR PAYAN

TANA ENGINEERS, INC

FIRE SPRINKLER DIFFERED SUBMITTAL PHOTOMETRIC/ LICENSED SPRINKLER

I ANDSCAPE ARCHITECT

SPLA

ENVIRONMENTAL: TANA ENGINEERS, INC RI ADIMIR PAYAN

UNIVER-CITY SOLAR SCOTT PETERSON

#### **GENERAL NOTES:**

- 1. A SEPARATE PERMIT IS REQUIRED FOR GRADING, RETAINING WALLS. FENCES FIRE SPRINKLERS, FIRE ALARM SYSTEM WHEN OCCURS MONUMENT SIGNAGE, TRASH ENCLOSURE, LIGHT STANDARDS, AND SWIMMING POOLS. THEY SHALL BE OBTAINED FROM THE DEVELOPMENT DEPARTMENT PRIOR TO INSTALLATION.
- 2. SITE PLAN IS NOT A BOUNDARY SURVEY.
- 3. PROPOSED CONSTRUCTION COMMENCEMENT DATE: -- /-- /--
- 4. PROPOSED CONSTRUCTION END DATE: --/-/--
- 5. NO EARTHMORK IS PROPOSED.
- 6. NO PROTECTED VEGETATION EXISTS ON THE PROJECT PROPERTY.
- 7. ROUGH INSPECTION OF PLUMBING, MECHANICAL, GAS, AND ELECTRICAL SYSTEMS SHALL BE MADE PRIOR TO COVERING OR CONCEALMENT, BEFOR FIXTURES OR APPLIANCES ARE SET OR INSTALLED, AND PRIOR TO FRAMIN
- 8. ALL GLAZING SHALL BE INSTALLED WITH A CERTIFYING LABEL ATTACHED SHOWING THE ULVALUE
- 9. WINDOWS ADJACENT TO TUBS, SHOWERS, STAIRWAYS, AND WITHIN 24" OF A DOORWAY SHALL BE TEMPERED.

#### **AREA TABULATIONS:**

TOTAL BUILDING AREA:	11,146 SQ. FT.
TOTAL LIVABLE AREA:	8,418 SQ.FT.
GARAGEAREA:	2,1105Q. FT.
BALCONY/PORCH:	618 SQ.FT.
COMMON AREA:	2,894 SQ.FT.

#### **UNIT TABULATIONS:**

UNIT A/D 1409 LIVABLE / 350 GARAGE / 140 BALCONY-PORCH UNIT B/E 1401 LIVABLE / 350 GARAGE / 140 BALCONY-PORCH 1401 LIVABLE / 350 GARAGE / 140 BALCONY-PORCH

## **MINIMUM ENERGY VALUES:**

EXTERIOR WALLS: 2X6 @ 16" O C INTERIOR MALLS: 2X4 @ 16" O.C. CEILING:

GLAZING: VINYL DUAL-PANE LOW-E 0.40 U-VALUE MIN.


DUCTS: WATER HEATER: R-12 INSULATION

AS PER ENERGY CALCULATIONS

HVAC:

LADEL	ITITLE	DESCRIPTION
G-1	PRESENTATION VIEWS	
G-1.1	PROJECT OVERVIEW	
SP-0	TENTATIVE TRACT MAP	
1	PRELIMINARY GRADING	
2	GRADING CROSS SECTIONS	
SP-1	SITE LAYOUT	
1A	SITE PLAN	
LP-1	COMMON/PRIVATE SPACE	
LP-1.0	LANDSCAPE PLAN	
SP-1.1	EROSION CONTROL	
SP-1.2	DRIVEWAY/CURB	
2	FOUNDATION PLAN	
	1ST FLOOR PLAN	
3.1	2ND FLOOR PLAN	
4	FRAMING/PLUMBING NOTES	
5	ROOF PLAN 1ST FLOOR	
5.1	ROOF PLAN 2ND FLOOR	
6	EXTERIOR ELEVATIONS	_
7	CROSS SECTIONS	
8	INTERIOR ELEVA.	
10	MECHANICAL	
11	ELECTRICAL	
P1.0	PHOTOMETRIC	
11.1	LIGHTING SPEC, DATA	
12	FENCE WALL PLAN	
52.0	FOUNDATION PLAN DETAIL	
	1ST LEVEL STRUCTURAL	
52.2	2ND LEVEL STRUCTURAL	
53.1	MISC. DETAILS CONT.	
53.1	MISC, DETAILS CONT.	
53.1	MISC. DETAILS	
SM1	SHEAR MAX DETAIL	
SM2	SHEAR MAX DETAIL	
SM3	SHEAR MAX DETAIL	
L-1	LANDSCAPE DETAIL	
GN	GENERAL NOTES	
LN	LANDSCAPE NOTES	
MM	MANDATORY MEASURES	STAIRS & RAILINGS
MM	MANDATORY MEASURES	GREEN GODE & FIRE ACCESS
MM	MANDATORY MEASURES	BLOCK MALL/ENCLOSURE
MM	MANDATORY MEASURES	
SCH	SCHEDULES	SCHEDULES & MATERIALS
CF1R	TITLE 24 ENERGY CALCS.	
CF1R	TITLE 24 ENERGY CONT.	
PV	SOLAR PHOTOVOLTAIC	
	SOLAR PHOTOVOLTAIC	
	G-11 SP-0 G-1.1 SP-0 G-1.1 SP-0 G-1.1 SP-0 G-1.1	6-1.1 PROJECT OVERVIEW  9-1.2 TENTATIVE TRACT MAP  1 PRELIMINARY GRADING  1 STEPLAN  1 STEPLAN  1 LE-1 COMMONIFRINATE SPACE  1.F-1 Q. LANDSCAPE PLAN  2.F-1 LE-1 COMMONIFRINATE SPACE  1.F-1 COMMONIFRIMATE SPACE  1.F-1 COMMONITRIA  1.F-1 COMMONITRIA

	THE DEAMINGS, DESIGNS, AND INFORMATION PROVIDED	REVISED BY PLANS ARE THE EXCLUSIVE PROPERTY OF RICHARDS DES	CONFIDENTIAL TO ALL RECIPIENTS AND NO PART OF THE	MAY BE COPIED, TRANSFERRED, OR REPRODUCED WITHO	WHITEN CONSENT OF ANDREW J. RICHANDG. THESE PL. INTENDED FOR THE SOLE FURFORE OF THE OWNER NOTE	COPYNONT 2019 RICHARDS DESIGN GROUP. NOTICE:	IT IS THE CLIENT'S MESPONSIBILITY PRIOR TO AND DURING CONSTRUCTION TO NOTIFY THE DESIGN PROFESSIONALS	OF ANY PERCEIVED ERRORA, OMISSIONS, OR DISCREPAN	TO PROCEEDING WITH WORK.	
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	-	DKAWIN	Ľ	ENGINEER:	DESIGNED BY: AJR	DRAWN BY: AJR	CHECKED BY: AJR	APPROVED BY: AJR		
		APN#: 191-200-028	VERTICAL/HORIZONTAL CONTROL:	The Care of the Country of the Count	SHEEL HILE: LOGOCI CVOLVION	PROJECT: DUNCAN GARDENS CONDO UNITS	COLOR TO THE PROPERTY OF THE P	ADDRESS: 4521 DUNCAN AVENUE, RIVERSIDE, CA 4,2505		
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# CITY OF RIVERSIDE SITE PLAN
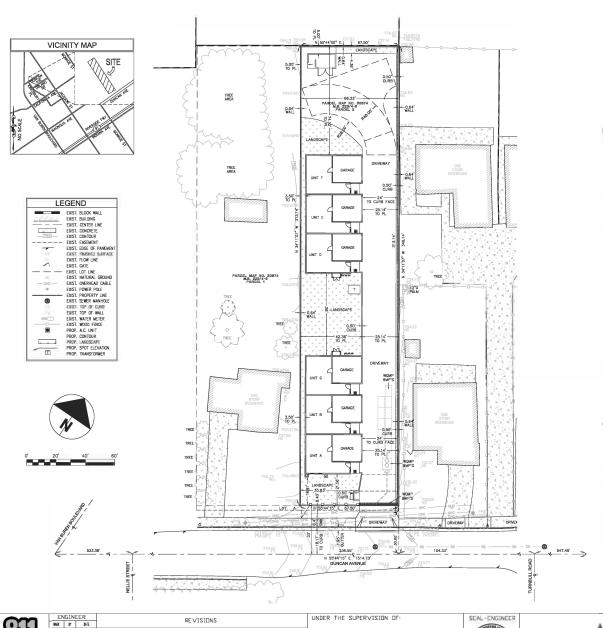
# DUNCAN GARDENS CONDO UNITS

# 9321 DUNCAN AVENUE RIVERSIDE, CA 92503

PROJECT MANAGEMENT:

ARCHITECT: RICHARD DESIGN GROUP 9569 PERIDOT AVENUE HESPERIA, CA 92344 (760)662-6769 A.RDGROUP8@GMAIL.COM CIVIL ENGINEER: TANA ENGINEERS, INC. 2404 MARY CLARE STREET CORONA, CA 92882 (949) 734-0093 BLADIMIR@TANAENGINEERS.COM LAND SURVEYOR:

PAYAN SURVEYING, INC. 2404 MARY CLARE STREET CORONA, CA 92882 (951)356-6456 ATANACIO®PAYANSURVEYING.COM

## FIRST AMERICAN TITLE COMPANY

ORDER NO.: 0623-6068631 DATED: OCTOBER 07, 2019

#### LEGAL DESCRIPTION:

REAL PROPERTY IN THE CITY OF RIVERSIDE, COUNTY OF RIVERSIDE, STATE OF CALIFORNIA, DESCRIBED AS FOLLOWS:

PARCEL 2 OF PARCEL MAP NO. 30874, IN THE CITY OF RIVERSIDE, COUNTY OF RIVERSIDE, STATE OF CALIFORNIA, AS PER PLAT RECORDED IN BOOK 223, PAGE 4 TO 6, OF PARCEL MAPS, RECORDS OF SAID COUNTY

ASSESSOR'S PARCEL NUMBER: 191-200-028-9

AREA: 21,137.09 S.F. (0.485 ACRES)

#### **EXCEPTION ITEMS:**

- 4 ANY AND ALL OFFERS OF DEDICATIONS, CONDITIONS, RESTRICTIONS, EASEMENTS, NOTES AND/OR PROVISIONS SHOWN OR DISCLOSED BY THE FILED OR RECORDED MAP REFERRED TO IN THE LEGAL DESCRIPTION INCLUDING BUT NOT LIMITED
  - TO: PUBLIC UTILITIES, AVIGATION, AND THE RIGHT OF FLIGHT FOR THE PASSAGE OF AIRCRAFT AND INCIDENTAL PURPOSES AFFECTING SAID LAND. THE LOCATION OF THE EASEMENT CANNOT BE DETERMINED FROM RECORD INFORMATION.
- (S) A ROUT OF MAY RESERVED TO THE INVERSION INVESTIGATION AND ITS ASSORD, FOR THE CONSTRUCTION AND DAMINETAMENCE OF ALL RECESSARY WATER DITCHES, PIERES FILMES AND APPRABATIS FOR THE PIERPOSES OF IRRIGATION MONO DOMESTIC USE AS GRANTED ON AUGUST 14, 1885 N BOOK 42 OF DEEDS PAGE 294, RECORDS OF SAN BERNARDING COUNTY, CALIFORNIA; THE EXACT LOCATION THEREOF NOT BEING DISCLOSED BY THE RECORDS.

THE LOCATION OF THE EASEMENT CANNOT BE DETERMINED FROM RECORD INFORMATION

#### BENCH MARK:

CITY OF RIVERSIDE BENCHMARK NO. 5052 ELEWATION = 811.264 FEET (NAVD 83 DATUM) 21999 FOUND 2\*1.P NO TAG DN. 0.7 STA 224-24.66 FER LL AT C.L. COOK AVE B.C. E'LY OF TOMLINSON

# BASIS OF BEARINGS:

THE BEARINGS SHOWN HEREON ARE BASED UPON THE CENTER LINE OF DUNCAN AVENUE, BEING N 55' 44' 15" E AS SHOWN ON PARCEL MAP NO. 30874 RECORDED IN BOOK 223, PAGES 4 TO 6, RECORDS OF RIVERSIDE COUNTY.

## AREA TABULATIONS:

#### TOTAL BUILDING AREA: 11.368 S.E. TOTAL LIVABLE AREA: 8,418 S.F. GARAGE AREA: 2,110 S.F. BALCONY/PORCH: 618 S.F. COMMON AREA: 2,282 S.F.

#### **UNIT TABULATIONS:**

1409 LIVABLE/350 GARAGE/140 BALCONY-PORCH 1401 LIVABLE/350 GARAGE/140 BALCONY-PORCH 1401 LIVABLE/350 GARAGE/140 BALCONY-PORCH

## **EARTHWORK QUANTITIES:**

2404 Mary Clare Street Corona, CA 92882

949-734-0093

bladimir@tanaengineers.com

CUT (RAW) 1441 C.Y. FILL (RAW) EXPORT (RAW) 1317 C.Y. 21,109 SQ. FT. TOTAL DISTURBED AREA (0.48 ACRES)

CITY OF RIVERSIDE

SITE PLAN

DUNCAN GARDENS CONDO UNITS 9321 DUNCAN AVENUE RIVERSIDE, CA 92503

SHEET NO.

1 DF1 SHTS

Exhibit 8 - Project Plans



02/16/23

BATE



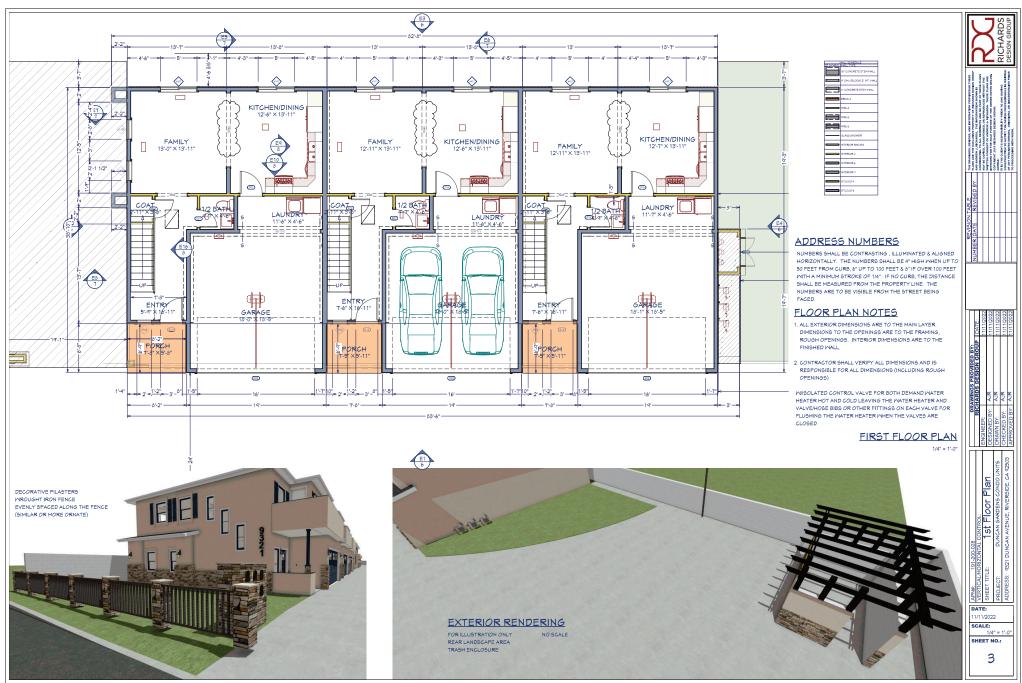


Exhibit 8 - Project Plans



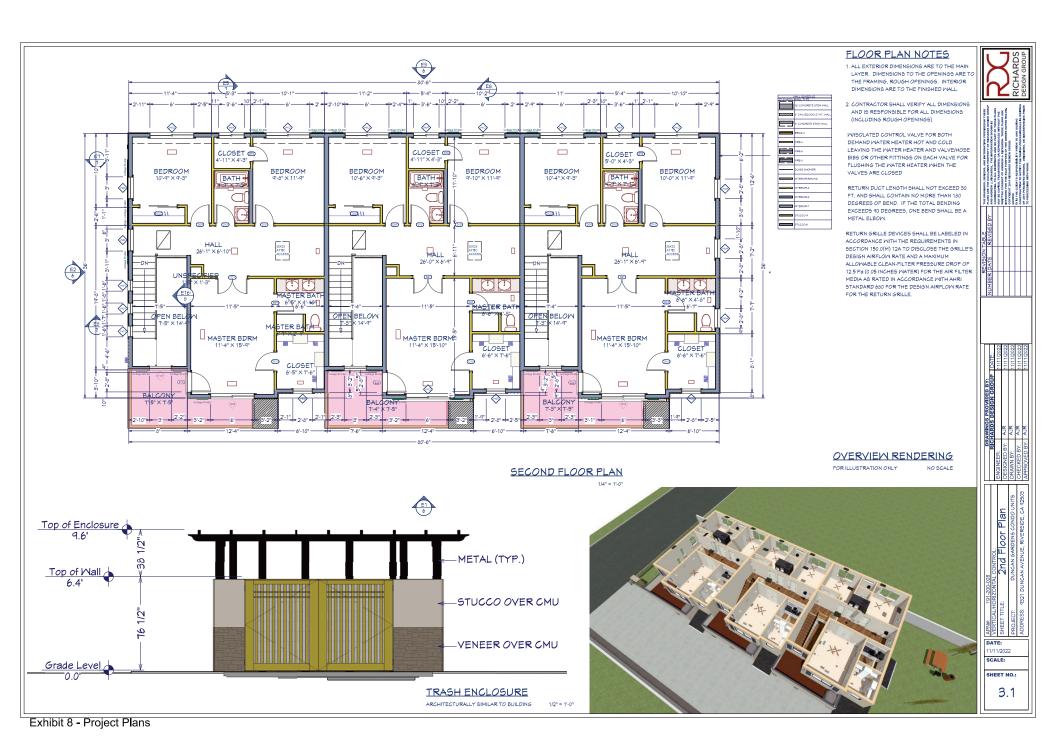

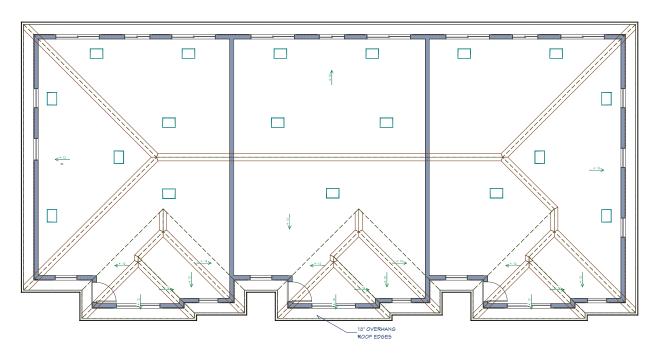

## SECOND FLOOR ROOF PLAN

## ATTIC VENTILATION CALS

TOTAL ATTIC AREA = 2,451

CALCULATION: 2451 SQ. FT. / 300 = 8.17 SQ. FT. OF FREE ATTIC VENTILATION REQUIRED 8.17 SQ. FT. (144) = 1,176 SQ. IN. FREE ATTIC VENTILATION REQUIRED

PROVIDE A VAPOR BARRIER NOT EXCEEDING (1) PERM. - INSTALL ON WARM SIDE OF ATTIC INSULATION. TOTAL ATTIC VENTILATION PROVIDED = 1,176 SQ. INCHES.

19 - O'HAGIN TAPERED LOW-PROFILE VENTS @ 12.0 SQ. FT. EACH (9) VENTS HIGH (10) VENTS LOW

#### GENERAL ELEVATION NOTES

A. PROVIDE APPROVED SPARK ARRESTOR ON CHIMNEY.

- B. LABEL ALL GLASS. SCREEN ALL OPENABLE VENTS.
- C. FLASH AND COUNTER FLASH ALL EXTERIOR OPENINGS.
- D. PROVIDE APPROVED G.I. STUCCO SCREED AT ALL EXTERIOR WALLS EXCEPT WHERE EXTERIOR SLAB IS PRESENT (UNLESS REQUIRED BY PERMITTING AUTHORITY).
- E. G.I. FLASHING AT ALL VALLEYS AND ROOF TO WALL CONNECTIONS.
- F. ANCHOR VENEER A 2 × 2 × 0.0625" CORROSION-RESISTANT WIRE MESH WITH TWO LAYERS OF WATER-RESISTIVE BARRIER IN ACCORDANCE WITH SEC. 1404.2 SHALL BE APPLIED DIRECTLY TO WOOD STUDS SPACED A MAXIMUM OF 16" O.C. ON STUDS, THE MESH SHALL BE ATTACHED WITH 2" LONG CORROSION-RESISTANT STEEL WIRE FURRING NAILS AT 4" O.C. PROVIDING A MINIMUM 1.125" PENETRATION INTO EACH STUD AND WITH 8d COMMON NAILS AT  $8^{\rm o}$ O.C. INTO TOP AND BOTTOM PLATES OR WITH EQUIVALENT WIRE TIES. THERE SHALL BE NO LESS THAN 0.1055" CORROSION-RESISTANT WIRE, OR APPROVED EQUAL, LOOPED THROUGH THE MESH FOR EVERY 2 SQ. FT. OF STONE VENEER. THIS TIE SHALL BE A LOOP HAVING LEGS NOT LESS THAN 15" IN LENGTH, SO BENT THAT IT WILL LIE IN THE STONE VENEER MORTAR JOINT. THE LAST 2" OF EACH WIRE LEG SHALL HAVE A RIGHT-ANGLED BEND. 1" MINIMUM THICKNESS OF CEMENT GROUT SHALL BE PLACED BETWEEN THE BACKING AND THE STONE VENEER.



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	REVISED BY	PLANS ARE THE EXCLUSIVE PROPERTY OF RECHARDS DESIGN GROUP
		CONFIDENTIAL TO ALL RECIPIENTS AND NO PART OF THESE PLANS
		MAY BE COMED, TRANSFERRED, OR REPRODUCED WITHOUT THE WHITTEN CONSENT OF ANDREW J. RECHARDS. THESE PLANS ARE
		INTENDED FOR THE SOLE PURPOSE OF THE OWNER NOTED BELOW.
		NOTICE NOT RECIVICION DESCRIPTION
П		IT IS THE CLEAT'S RESPONSEELTY PRIOR TO AND DURING
		OF ANY PERCEIVED ERRORS, ORESISONS, OR DECREPANCIES PROR
		TO PROCEEDING WITH WORK.

DR	AWINGS PROVIDED BY:	
RICI	<b>HARDS DESIGN GROUP</b>	DATE:
ENGINEER:		11/11/2022
DESIGNED BY:	AJR	11/11/2022
DRAWN BY:	AJR	11/11/2022
CHECKED BY:	AJR	11/11/2022
APPROVED BY:	AJR	11/11/2022

RIZOUZZE RIZONTAL CONTROL:  ROOF Plan;  DUNCAN GARDE 21 DUNCAN AVENUE; RI	I ZONTAL CONTROL:	Roof Plan 2nd Floor	DUNCAN GARDENS CONDO UNITS	21 DUNCAN AVENUE, RIVERSIDE, CA 42503
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11/11/2022 SCALE:

SHEET NO.: 5.1





Exhibit 8 - Project Plans

# -0.64 WALL TREE 757.56TC 757.06FL 763.77TFW 757.77TRW EL MAP NO. 30874 M.B. 223/4-8 PARCEL 1 765.65TFW 759.65TRW 755.65TF/FI 754.49T 3.50 -TO PL 760.771FV 754.771RV ENGINEER UNDER THE SUPERVISION OF

# CITY OF RIVERSIDE PRELIMINARY GRADING PLAN FOR:

DUNCAN GARDENS CONDO UNITS

#### 9321 DUNCAN AVENUE RIVERSIDE, CA 92503

PROJECT MANAGEMENT:

ARCHITECT:

CIVIL ENGINEER:

TANA ENGINEERS, INC. 2404 MARY CLARE STREET CORONA. CA 92882

LAND SURVEYOR:

PAYAN SURVEYING, INC. 2404 MARY CLARE STREET CORONA. CA 92882 (951)356-6456 ATANACIO@PAYANSURVEYING.COM

#### FIRST AMERICAN TITLE COMPANY

ORDER NO.: 0623-6068631 DATED: OCTOBER 07, 2019

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ASSESSOR'S PARCEL NUMBER: 191-200-028-9

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- (3) A RICHT OF WAY RESERVED TO THE RIVERSIDE WATER COMPANY, AND ITS ASSIGNS, FOR THE CONSTRUCTION AND MAINTENANCE OF ALL NECESSARY WATER DITCHES, PIPES, FLUMES AND APPARATILS FOR THE PURPOSES OF IRRIGATION AND DOMESTIC USE AS GRANTED ON AUGUST 14, 1885 N BOOK 42 OF DEEDS PAGE 294, RECORDS OF SAN BERNARDING COUNTY, CALIFORNIA; THE EXACT LOCATION THEREOF NOT BEING DISCLUSSED BY THE RECORDS.

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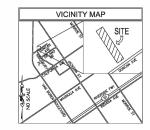
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## **EARTHWORK QUANTITIES:**

CUT (RAW) 1.441 C.Y. FILL (RAW) 124 C.Y. EXPORT (RAW) TOTAL 1,217 C.Y. 21,109 SQ. FT. DISTURBED AREA (0.48 ACRES)







REVISIONS

02/16/23 BATE RCE# 30946 (EXP. 03/3L/2022)






2404 Mary Clare Street Corona, CA 92882 949-734-0093 bladimir@tanaengineers.com CITY OF RIVERSIDE


## PRELIMINARY GRADING PLAN


DUNCAN GARDENS CONDO UNITS 9321 DUNCAN AVENUE RIVERSIDE, CA 92503

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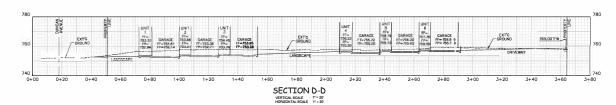
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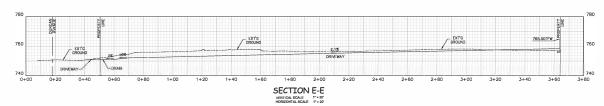





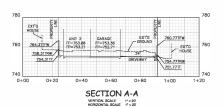

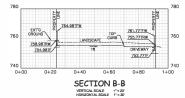FF FINNSHED FLOOR
FP FINNSHED PAO
IFW IDFO OF REESANDING WALL
ITW TOP OF FEDINING WALL
IF TOP OF FOOTING

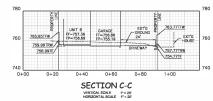



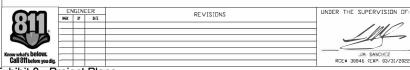





2404 Mory Clare Street Corona, CA 92882 949-734-0093 bladimir@tanaengineers.com CITY OF RIVERSIDE

**CROSS SECTIONS** 

DUNCAN GARDENS CONDO UNITS 9321 DUNCAN AVENUE RIVERSIDE, CA 92503 SHEET NO.

2 DF2 SHTS

#### SITE PLAN NOTES:

- 1. SITE SURVEY TO BE COMPLETED TO VERIFY PIN LOCATIONS AND HOME LOCATION PRIOR TO EXCAVATION.
- 2. CALL BEFORE DIG: 811
- 3. NO PROTECTED PLANTS ON SITE
- 4. ALL WALLS ARE RETAINING WALLS

#### **EROSION CONTROL NOTES:**

- 1. INSTALL SILT FENCE PRIOR TO EXCAVATION OR CONSTRUCTION.
- 2. MINIMIZE SITE DISTURBANCE BY TIGHT CONTROL OF EXCAVATION LIMITS
- 3. ALL EXPOSED SOIL SHALL BE MULCHED WITH STRAW OR MOOD CHIPS TO MINIMIZE SOIL EROSION. NO SOILS SHALL BE LEFT IN AN EXPOSED CONDITION. IT IS RECOMMENDED THAT THE CONTRACTOR MAINTAIN A STOCK PILE OF THIS MATERIAL ON SITE FOR QUICK APPLICATION.
- 4. HYDROSEED WITH A WOOD CELLULOSE FIBER MULCH APPLIED AT A RATE OF 2000 #/AGRES. USE AN ORGANIC TACKIFIER AT NO LESS THAN 150 #/AGRE OR PER MANUFACTURER'S RECOMMENDATION IF HIGHER. APPLICATION OF TACKIFIER SHALL BE HEAVIER AT EDGES IN VALLEYS AND AT CRESTS OF BANKS AND OTHER AREAS WHERE SEED CAN BE MOVED BY WIND OR WATER.
- 5. DISPERSION TRENCHES SHALL OVERFLOW ONTO NATIVE UNDISTURBED GROUND. NO SITE DISTURBANCE BELOW TRENCHES
- 1. CONTRACTOR TO VERIFY LOCATION OF ALL EXISTING UTILITIES.
- 2. PROVIDE POSITIVE DRAINAGE AWAY FROM BUILDING
- 3. FINAL GRADE TO CONVEY SURFACE DRAINAGE TOWARD ROCK CHANNELS AND DISPERSION TRENCHES
- 4. AREAS TO BE FILLED SHALL BE GLEARED, GRUBBED TO REMOVE TREES, VEGETATION, ROOTS AND OTHER OBJECTIONABLE MATERIAL AND STRIPPED OF TOPSOIL
- 5. PLACE FILL SLOPES WITH A GRADIENT STEPPER THAT 3:1 IN LIFTS NOT TO EXCEED 8 INCHES AND MAKE SURE EACH LIFT IS PROPERLY COMPACTED.
- 6. PAD AT RESIDENCE SHALL BE OVER-EXCAVATED 2'-0" AND REPLACED IN 12" LIFTS AND RE-COMPACTED TO 90% - ALL LAND DISTURBANCE IS APPROX. 10.900 SQ. FT. - CUT = 37 CUBIC YARDS, FILL = 37 CUBIC YARDS.

#### SLAB NOTES:

FOUNDATION SLAB SHALL BE A MINIMUM 8" ABOVE GRADE.

ALL WORK WITHIN A PUBLIC RIGHT-OF-WAY IS REQUIRED TO HAVE AN ENGROACHMENT PERMIT BY THE PUBLIC WORKS DEPARTMENT

1/8" MIN. SLOPE - GRADE SHALL FALL 6" WITHIN THE FIRST 10' OF

PROVISIONS FOR CONTRIBUTORY DRAINAGE SHALL BE MADE AT ALL TIMES

THE GROUNDS IMMEDIATELY AD IACENT TO THE FOUNDATION SHALL BE SLOPED AWAY FROM THE BUILDING AT A SLOPE OF NOT LESS THAN 6" (5 PERCENT SLOPE) IN THE FIRST 10 FEET MEASURED PERPENDICULAR TO THE FACE OF THE WALL IMPERVIOUS SURFACES WITHIN 10 FEET OF THE BUILDING SHALL BE SLOPED A MINIMUM OF 2 PERCENT AWAY FROM THE BUILDING. (CRC R401.3)

EXCEPTION: WHERE LOT LINES, WALLS, SLOPES OR OTHER PHYSICAL BARRIERS PROHIBIT. 6 INCHES OF FALL WITHIN 10 FEET, DRAINS OR SWALES SHALL BE CONSTRUCTED WITH A MINIMUM SLOPE OF 2% IN THE DIRECTION OF FLOW TO ENSURE DRAINAGE AWAY FROM THE STRUCTURE



THE GROUNDS IMMEDIATELY ADJACENT TO THE FOUNDATION SHALL BE SLOPED AWAY FROM THE BUILDING AT A SLOPE OF NOT LESS THAN 6" (5 PERCENT SLOPE) IN THE FIRST 10 FEET MEASURED PERPENDICULAR TO THE EACE OF THE WALL. IMPERVIOUS SURFACES WITHIN 10 FEET OF THE BUILDING SHALL BE SLOPED A MINIMUM OF 2 PERCENT AWAY FROM THE BUILDING. (CRC R401.3)

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6 INCHES OF FALL WITHIN 10 FEET, DRAINS OR SWALES SHALL BE CONSTRUCTED WITH A MINIMUM SLOPE OF 2% IN THE DIRECTION OF FLOW TO ENSURE DRAINAGE AWAY FROM THE STRUCTURE.



EXTERIOR RENDERING

## 3. ALL GRADING IS TO BE DONE IN ACCORDANCE WITH THIS PLAN AND

- THE CITY OF RIVERSIDE STANDARDS & SPECIFICATIONS
- 4. ALL SLOPES SHALL BE 2 HORIZONTAL TO 1 VERTIGAL MAX.
- 5. THE CONTRACTOR SHALL PROVIDE ADEQUATE DUST CONTROL
- 6. ALL WASTE VEGETATION AND REFUSE SHALL BE REMOVED BEFORE GRADING. NO FILL TO BE PLACED UNTIL PREPARATION OF THE ORIGINAL GROUND IS APPROVED.
- 7. SCARIFY GROUND TO A DEPTH OF 6" BEFORE GRADING. PLACE FILL IN 8" LIFTS WITH ROCKS NO GREATER THAN 8".
- 8. ALL COMPACTED FILL AREAS SHALL BE PLACED TO 90% OF MAXIMUM DENSITY AND ALL COMPACTION TESTS IN FILL SHALL BE TAKEN AT A MAXIMUM OF 2' VERTICAL INTERVALS, PER A S.T.M., D1557-78
- 9. THE FOUNDATION BEARING VALUE SHALL BE MINIMUM 1500 P.S.F. 10. A MINIMUM OF 1 COMPACTION TEST IN THE CUT AREA AND 1 COMPACTION TEST IN THE FILL AREA ARE REQUIRED. THE CONTRACTOR SHALL SUBMIT A COMPACTION TEST AND OBTAIN APPROVAL PRIOR TO FOUNDATION INSPECTION. 11. EXCAVATION: 700 C.Y. (15-20% LOSS DUE TO SHRINKAGE IS ASSUMED).
- 12. EMBANKMENT:560 C.Y

**GENERAL NOTES:** 

1. INDICATES EXISTING GROUND ELEVATIONS.

2. INDICATES PROPOSED GROUND ELEVATIONS.

13. TRANSPORTATION DEPARTMENT PERMIT IS REQUIRED FOR ANY CONSTRUCTION TEMPORARY OR PERMANENT, ON CITY RIGHT OF WAY, OR FOR USE OF CITY MAINTAINED ROADS BY OVERLOAD EQUIPMENT.

14. CONTACT THE GRADING INSPECTOR A MINIMUM OF 48 HOURS BEFORE START FOR AN ON SITE PRE-GRADING MEETING \*\* IMPORT: C.Y. COMPACTED ON SITE FOR ANY IMPROVED AREA.

15. PLACE PORTABLE TOILET NEAR STABILIZED SITE ENTRANCE, BEHIND THE CURB AND AWAY FROM GUTTERS, STORM DRAIN INLETS, AND WATER BODIES. TIE OR STAKE PORTABLE TOILET TO PREVENT TIPPING AND EQUIP UNITS WITH OVERFLOW PAN/TRAY

16. DESIGNATE WASTE COLLECTION AREA ON SITE. USE WATERTIGHT DUMPSTER AND TRASH CANS; INSPECT FOR LEAKS. COVER AT THE END OF EACH WORK DAY AND WHEN IT IS RAINING OR WINDY. ARRANGE FOR REGULAR WASTE COLLECTION. PICK UP SITE LITER DAILY.

## DESIGN CRITERIA AND **SPECIFICATIONS**

- DOUGLAS FIR LARCH (NORTH), 19% MOISTURE CONTENT
- 1) 2" × IOISTS AND RAFTERS #2 OR BETTER
- 2) 4" ×, 6" ×, 8" × BEAMS AND HEADERS #1 OR BETTER 3) PLATES, BLOCKING AND STUDS - STUDS GRADE OR
- B. GLUED-LAMINATED BEAM:
- COMBINATION: 24F-V4 SPECIES: DF/DF
- 3000 PSI MINIMUM STRENGTH AT 28 DAYS D. STEEL:
  - 1) ASTM A36 FUE36 ksi FOR STRUCTURAL STEEL
  - 2) ASTM A615, GRADE 40 FOR #3 AND #4, GRADE
  - 60 FOR #5 AND LARGER REBAR STEEL 3) ASTM A53, GRADE B FOR PIE STEEL
  - 4) ASTM A500, GRADE B FOR TUBE STEEL
  - ANCHOR BOLTS A307

PREFAB WOOD JOISTS - ASTM D5055 GILLE LAMS - ANGL/ AITC AGO 1 & AGTM D3737 WOOD STRUCTURE PANELS - DOC PS 1 OR PS 2 PARTICLEBOARD - ANSI A208.1 TREATED MOOD - AMPA STANDARD U1 & M4 NAILS AND STAPLES - ASTM F1667

## GENERAL INFORMATION

A. DRAWINGS AND SPECIFICATIONS ARE INTENDED TO BE COMPLEMENTARY, SPECIFIC INFORMATION MAY BE FOUND IN EITHER

FOR ILLUSTRATION ONLY

- B. LAYOUT OF MORK:
- 1) EXERCISE PROPER PRECAUTION TO VERIEY ALL EXISTING CONDITIONS AND LAYOUT OF WORK.
- CONTRACTOR SHALL NOTIFY ARCHITECT/DRAFTING DESIGNER OF ANY DISCREPANCIES IMMEDIATELY. 2) CONTRACTOR IS RESPONSIBLE FOR ANY ERRORS RESULTING
- FROM FAILURE TO EXERCISE SUCH PRECAUTIONS: SUCH ERRORS WILL NOT BE CONSIDERED SUBSEQUENTLY AS A BASIS FOR EXTRA
- 3) THE CONTRACTOR SHALL BE RESPONSIBLE FOR LAYOUT WORK, ALL LINES, MEASUREMENTS OF THE BUILDING, UTILITIES, AND OTHER WORK EXECUTED UNDER THE CONTRACT.
- 4) SHOULD A CONTRACTOR FIND DISCREPANCIES IN OR OMISSIONS FROM THE DRAWINGS OR SPECIFICATIONS, OR SHOULD THEY BE IN DOUBT AS TO THE MEANING, HE SHALL AT ONCE NOTIFY THE ARCHITECT/ DRAFTING DESIGNER. C EXAMINATION:
- 1) ANY DISCREPANCIES, ERRORS OR OMISSIONS DISCOVERED IN THE CONTRACT DOCUMENTS BY THE CONTRACTOR SHALL BE BROUGHT TO THE ATTENTION OF THE ARCHITECT/DRAFTING DESIGNER BEFORE PROCEEDING WITH RELATED WORK, OTHERWISE THE CORRECTION OF SUCH ITEMS IS THE RESPONSIBILITY OF THE CONTRACTOR. D. CODES AND STANDARDS:
- 1) ALL WORK MATERIALS AND INSTALLATION SHALL BE IN STRICT ACCORDANCE WITH ALL ORDINANCES, STATE AND LOCAL BUILDING CODES LATEST EDITION
- 2) DESIGN LOADS: LOADS AND CODE RESTRICTIONS FOR ALL DESIGN CONSIDERATIONS SHALL CONFORM TO THE LOCAL, STATE AND ALL GOVERNING CODES.

DRAWINGS PROVIDED BY:	RICHARDS DESIGN GROUP DATE		ENGINEEK: 11/11/2022	ESIGNED BY: AJR 11/11/2022	RAWN BY: AJR 11/11/2022	CHECKED BY:   AJR	A.IR	
		LINE.		one radont	DUNCAN GARDENS CONDO UNITS DRA	T	ADDRESS: 9321 DUNCAN AVENUE, RIVERSIDE, CA 92503	
191-200-028	A HODIZONTAL CONT	CALL DOUGLOS IN THE COLUMN	CHECKTER C.	9	PROJECT: DUNCAN		ESS: 4921 DUNCAN AVE	

11/11/2022

SHEET NO.:


SP-1


1" = 20'-0"

SCALE:

## **Fiber Rolls**




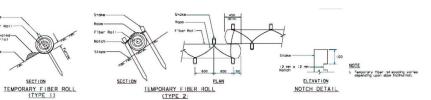

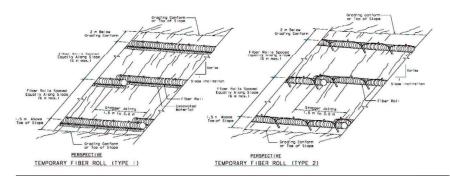


# **Concrete Waste Management**



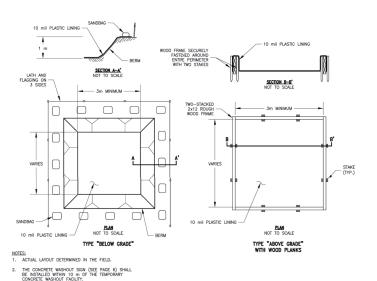

#### SMALE DETAIL

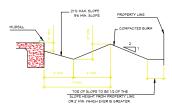

#### SPILLWAY DETAIL TO STREET



RETENTION FOND SPILLMAYS ARE TO BE:

- LEYEL AND 19 MINIMUM IN LENGTH
   TO HAVE THE ENDS RISE AT LEAST 0.2 FEET (ABOUT 2-50°)
   NO POINT OF THE POIND PERIMETER MAP DROP BELOW THE ELEVATED ENDS OF THE SPILLIVAY
- DIRT FORMING POND PERIMETER IS TO BE COMPACTED.
   DEPTH FROM POND BOTTOM TO POND OUTLET IS NOT TO EXCEED 0.5" MAXIMUM

THE PURPOSE OF THE SPILLMAY IS TO HELP ENSURE SHEET FLOW FOR STORMMATER OVERFLOWS.

#### SPILLWAY DETAIL



ETENTION POND SPILLIAMYS ARE TO BE:

I. MADE OF COKRETTE. GONCRETE BLOCK OR OTHER
APPROVED MATERIAL.

2. LEVEL AND 19 MINIMUM IN LENGTH


3. TO HAVE THE ENDS RISE AT LEAST 0.2 FEET (ABOUT 2-36")

4. NO POINT OF THE POND PERIMETER MAP DROP BELLOW THE
ELEVATED BUSS OF THE SPILLIAMY

- DIRT FORMING POND PERIMETER IS TO BE COMPACTED.
   DEPTH FROM POND BOTTOM TO POND OUTLET IS NOT TO EXCEED 0.5' MAXIMUM

THE PURPOSE OF THE SPILLMAY IS TO HELP ENSURE SHEET FLOW FOR STORMMATER OVERFLOWS.

## CONSTRUCTION ENTRANCE

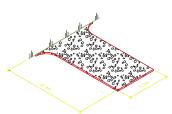

## **Solid Waste Management**



#### **BMP Objectives**

- Soil Stabilization
- Tracking Control
- Wind Erosion Control
  Non-Storm Water Management
- Materials and Waste Manageme

#### SITE PLAN NOTES:

- 1. SITE SURVEY TO BE COMPLETED TO VERIFY PIN LOCATIONS AND HOME LOCATION PRIOR TO EXCAVATION.
- 2. CALL BEFORE DIG: 811

#### **EROSION CONTROL NOTES:**

- 1. INSTALL SILT FENCE PRIOR TO EXCAVATION OR CONSTRUCTION. 2. MINIMIZE SITE DISTURBANCE BY TIGHT CONTROL OF EXCAVATION LIMITS.
- 3. ALL EXPOSED SOIL SHALL BE MULCHED WITH STRAW OR WOOD CHIPS TO MINIMIZE SOIL EROSION. NO SOILS SHALL BE LEFT IN AN EXPOSED CONDITION. IT IS RECOMMENDED THAT THE CONTRACTOR MAINTAIN A STOCK PILE OF THIS MATERIAL ON SITE FOR QUICK APPLICATION.
- 4. HYDROSEED WITH A WOOD CELLULOSE FIBER MULCH APPLIED AT A RATE OF 2000 #/ACRES. USE AN ORGANIC TACKIFIER AT NO LESS THAN 150 #/AGRE OR PER MANUFACTURER'S RECOMMENDATION IF HIGHER. APPLICATION OF TACKIFIER SHALL BE HEAVIER AT EDGES IN VALLEYS AND AT CRESTS OF BANKS AND OTHER AREAS WHERE SEED CAN BE MOVED BY MIND OR MATER.
- 5. DISPERSION TRENCHES SHALL OVERFLOW ONTO NATIVE UNDISTURBED GROUND. NO SITE DISTURBANCE BELOW TRENCHES.
- 1. CONTRACTOR TO VERIFY LOCATION OF ALL EXISTING UTILITIES.
- 2. PROVIDE POSITIVE DRAINAGE AWAY FROM BUILDING.
- 3. FINAL GRADE TO CONVEY SURFACE DRAINAGE TOWARD ROCK CHANNELS AND DISPERSION TRENCHES
- 4. AREAS TO BE FILLED SHALL BE CLEARED, GRUBBED TO REMOVE TREES, VEGETATION, ROOTS AND OTHER OBJECTIONABLE MATERIAL AND STRIPPED OF TOPSOIL
- 5. PLACE FILL SLOPES WITH A GRADIENT STEPPER THAT 3:1 IN LIFTS NOT TO EXCEED 8 INCHES AND MAKE SURE EACH LIFT IS PROPERLY COMPACTED.
- 6. PAD AT RESIDENCE SHALL BE OVER-EXCAVATED 2'-0" AND REPLACED IN 12" LIFTS AND RE-COMPACTED TO 90% - ALL LAND DISTURBANCE IS APPROX. 10,900 SQ. FT. - GUT = 37 GUBIC YARDS, FILL = 37 CUBIC YARDS.

## SLAB NOTES:

FOUNDATION SLAB SHALL BE A MINIMUM 8" ABOVE GRADE.

ALL WORK WITHIN A PUBLIC RIGHT-OF-WAY IS REQUIRED TO HAVE AN ENGROACHMENT PERMIT BY THE PUBLIC WORKS DEPARTMENT

1/8" MIN. SLOPE - GRADE SHALL FALL 6" WITHIN THE FIRST 10' OF

PROVISIONS FOR CONTRIBUTORY DRAINAGE SHALL BE MADE AT

11/11/2022

SCALE:

SHEET NO.:

SP-1.1

# **TENTATIVE** TRACT MAP NO. 37865 IN THE CITY OF RIVERSIDE

BEING A PROPOSED SUBDIVISION OF PARCEL 2 OF PARCEL MAP NO. 30874, AS PER PLAT RECORDED IN BOOK 223, PAGES 4 AND 6 OF PARCEL MAPS, RECORDS OF THE COUNTY OF RIVERSIDE, STATE OF CALIFORNIA

LOT 1 IS FOR CONDOMINIUM PURPOSES

PROPERTY ADDRESS:

9321 DUNCAN AVENUE RIVERSIDE, CA 92503

OWNER/DEVELOPER:

RIVERCAL, LLC
c/o LONNE DUPLECHAN
4328 CANTEEN TRAIL
COLORADC SPRINGS, CO 80922

PREPARED BY:

LEGAL DESCRIPTION:
REAL PROPERTY IN THE CITY OF RIVERSIDE, COUNTY OF RIVERSIDE, STATE OF CALIFORNIA, DESCRIBED AS FOLLOWS:

PARCEL 2 OF PARCEL MAP NO. 30874, IN THE CITY OF RIVERSIDE, COUNTY OF RIVERSIDE, STATE OF CALLFORNIA, AS PER PLAT RECORDED IN BOOK 223, PAGE 4 TO 6, OF PARCEL MAPS, RECORDS OF SAID COUNTY.

THE BEARNOS SHOWN HEREON ARE BASED UP(N THE CENTER LINE OF DUNCAN AVENUE, BEING N. 55' 44' 15' E AS SHOWN ON PARCEL MAP 80, 30874 RECORDED IN BOOK 223, PAGES 4 TO 6, RECORDS OF INVERSIBLE COUNTY.

#### BENCHMARK:

BENCHMARK: CITY OF RIVERSIDE BENCHMARK NO. 5052 ELEVATON = 811.264 FEET (NAVD 83 DATUM) 21999 FOUND 2°1 IP NO TAG DN. 0°7 STA 224-24.66 FER LL AT C.L. COOK AVE B.C. E'LY OF TOMLINSON

#### MONUMENT NOTES:

\*\* INDICATES FOUND MONIMENT AS DESCRIBED HEREON.
 \*\* I = 3/4\* LP-, DOWN 0.55\* PR.
 \*\* I = 1/2\* LP-, WITH N/T
 \*\* I = 4/4\* LP-, DOWN 0.55\* PR.
 \*\* I = 4/4\* LP-, DOWN 0.55\* PR.
 \*\* I = 5/4\* LP-, WITH N/T
 \*\* I = 5/4\* RIVERSIDE CITY SURVEYOR\* PER P.M.B. 223/4-5
 \*\* SW RIVERSIDE CITY SURVEYOR\* PER P.M.B. 223/4-5

NOTE:

MAP IS BASED ON TOPOGRAPHIC SURVEY PREPARED BY PAYAN SURVEYING, INC. ON OCTOBER 18, 2019.

#### AREAS:

PROPOSED BUILDING 1 = 3,183.18 S.F. PROPOSED BUILDING 2 = 3,175.79 S.F.

PROPOSED HARDSCAPE AREA = 10,912.64 S.F.

PROPOSED LANDSCAPE AREA = 3.865.48 S.F.

TOTAL AREA = 21,137.09 S.F. (0.485 ACRES)

PREPARED BY ME OR UNDER MY DIRECTION AND SUPERVISON












PARCEL MAP NO. M.B. 223/4-8

N UNIT F

LOT 1

UNIT D

PARCEL MAP NO. 30874 M.B. 223/4-8 PARCEL 1

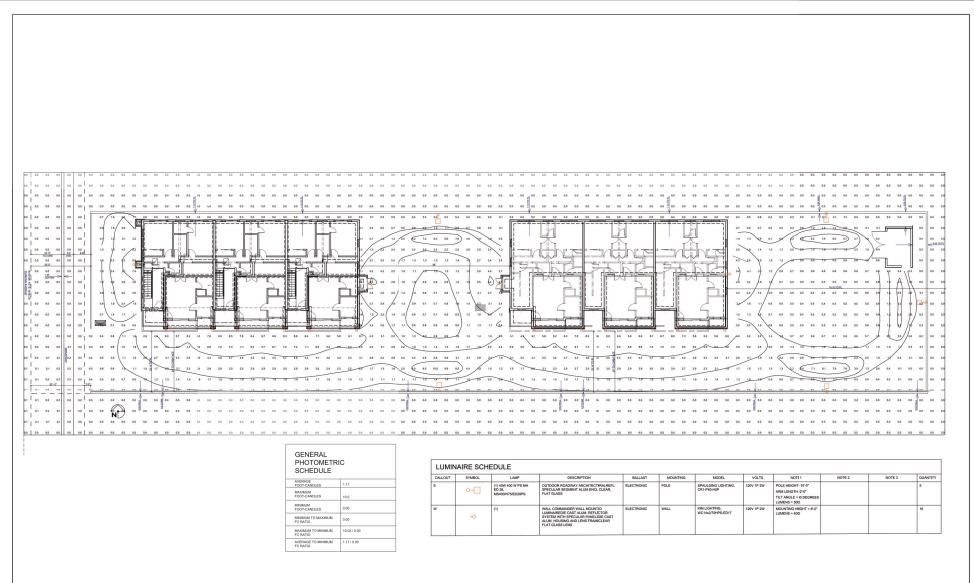






6 UNIT CONDOMINIUM PROJECT
PROJECT ADDRESS
9321 DUNCAN AVENUE, RIVERSIDE, CA 92503

SHEET TITLE:
PHOTOMETRIC PLAN
SHEET SCALE:

SHEET NUMBER

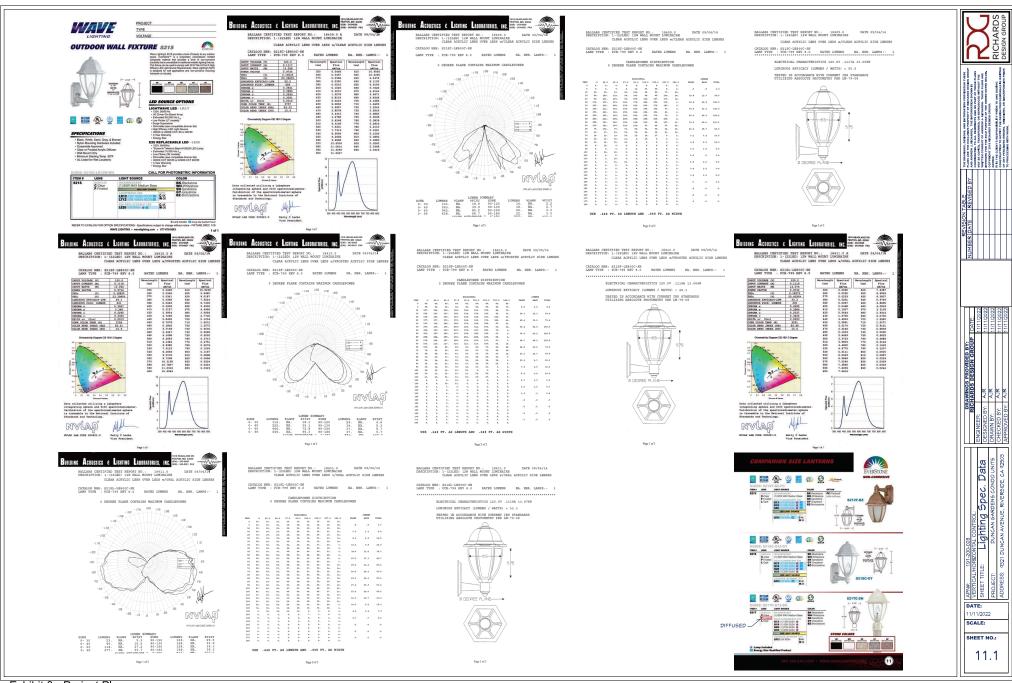



CONSULTANTS

2 Flintridge RVINE, CA 92603

PLANTING PLAN

20' 40' SCALE: 1" = 20'-0"

LP-1.0

# PLANTING LEGEND TREES



SHRUBS &	ACCENT SUCCULENTS	
SYMBOL	NAME	WUCOLS
0	FICUS PUMILA, CREEPING FIG 5 GAL @ 60" O.C.	м
0	WESTRINGIA FRUTICOSA "WYNABIE GEM", COAST ROSEMARY 5 GAL @ 36" O.C.	L
	I IGUSTRUM TEXANUM, TEXAS PRIVET 5 GAL. @ 36" O.C.	L
*	AGAVE WEBERI, WEBER'S AGAVE 5 GAL. SIZE	L
(3)	DODONAEA VISCOSA, HOPSEED BUSH 5 GAL @ 48" O.C.	L

SYMBOL	NAME	WUCOLS
	LOMANDRA LONGIFOLIA BREEZE,DWARF MAT RUSH 1 GAL @ 24" O.C.	· ·
	LANTANA CAMARA 'DWARF GOLD', DWARF LANTANA 1 GAL SIZE @ 30° O.C.	, e
	CHONDROPETALUM TECTORUM, SMALL CAPE RUSH 1 GAL @ 36" O.C.	L
	MUHLENBERGIA DUBIA, PINE MUHLY 1 GAL @ 36" O.C.	L
	SALVIA CLEVLANDII, CLEVLAND SAGE 5 GAL @ 48" O.C.	i.
	DIANELLA TASMANICA VARIEGATA', WHITE STRIPED TASMAN FLAX LILY 1 GAL @ 24" O.C.	L
*	NEW TURF SOD MARATHON II, TALL FESCUE	м

#### PLANTING NOTES:

- ALL PLANTING AREAS TO RECEIVE A 3° LAYER OF SMALL BARK MULCH. PROVIDE PRODUCT DATA AND SAMPLE FOR LANDSCAPE ARCHITECT TO REVIEW PRIOR TO INSTALLATION
- ALL TREES PLANTED WITHIN 4" OF CURB, WALKWAY, WALL OR BUILDING TO BE INSTALLED WITH DEEP ROOT BARRIER PANELS UB-24 24" DEEP, 8" LONG;
- ALL TREES TO BE PLANTED A MIN. OF 4' CLEAR FROM ANY UNDERGROUND UTILITIES.



0000000

ONE STORY RESIDENCE

MUHLENBERGIA DUBIA SALVIA CLEVELANDII -

CAST IN PLACE CO NCRETE SEAT WALL, 18" MAX HT. X 20" DEEP

NATURAL GRAY CONCRETE PAVING. MEDIUM BROOM FINISH

MATOH LINE

- LOMANDRA L. - AGAVE WEBERII

DUNCAN AVENUE

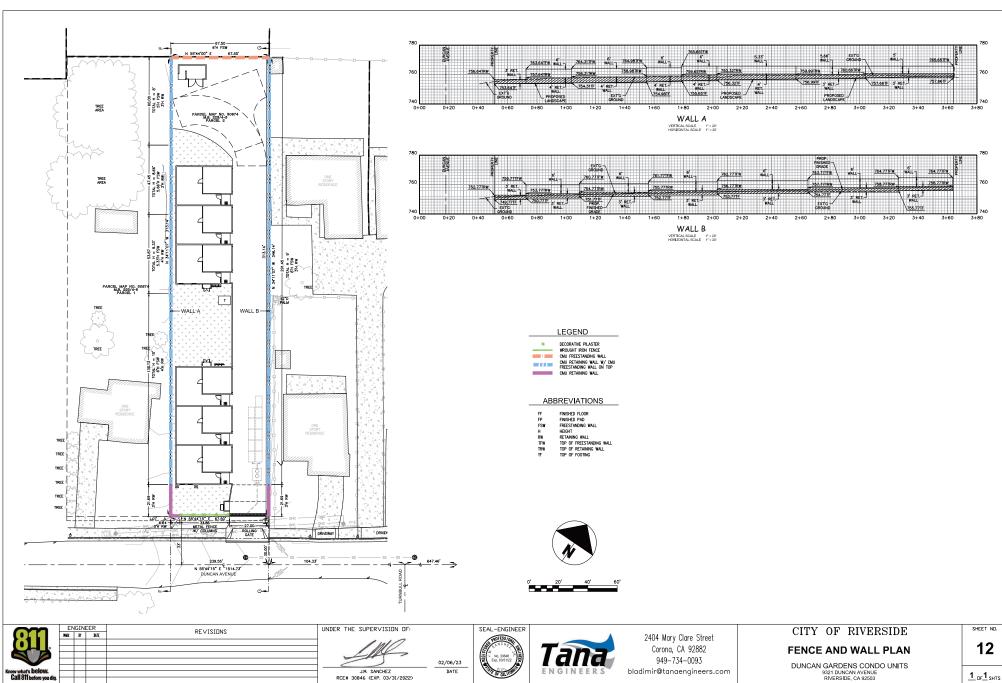


Exhibit 8 - Project Plans







Feature	Cementitious	Acrylic
Application Thickness	1/8 inch (3 mm)	1/16 inch (1.5 mm)
	Helps to compensate for wall irregularities.	Does not easily hide wall irregularitie.
Ease of Application	More labor intensive than acrylic stucco finish.	Less labor intensive than cement stuco finish.
	Usually requires mortar mixer.	No jobsite plaster mixer required.
Application Temperature Range	40°F (4.4°C) to 120°F (49°C).	40°F (4.4° C) to 120°F (49°C).
Ease of Clean-Up	Less difficult than acrylic stucco finish.	More difficult than cementitious finish since it can stain surrounding surfaces. Solvents may be require to remove dried finish from surrounding materials.
Vapor Permeability	Highly vapor permeable.	Vapor permeable, greater than 10. Prm rating will vary by the texture of the acrylic stuco finish.
Initial Color Consistency on Wall	Surface color may vary, due to substrate conditions, slightly creating a mottled look (can be made more consistent with Allegro II or Fog Coat).	Excellent initial color consistency on vall, more color uniformity than cementitious firish.
Assortment of Colors	Good range of colors, but limited in comparison to acrylic stucco finish. Custom and darker colors are more difficult to match with cementitious finishes.	Unlimited colors are possible. Colors are easily matched in acrylic finishes.
Finish Appearance	Good depth of color and texture. Mottling may appear, due to job and application conditions.	Very uniform.
Range of Textures	Numerous textures may be achieved depending on applicators skill. (Smooth hard trowel to heavy Spanish).	Range of textures are available depending on the skill of the applicator and aggregate gradation in acrylic finish. Heavy Spatish type of texture not easily achieved.
Color Permanency/Uniformity	More color permanency than acrylic finish. Colors typically darken with age. Good uniformity, but not as good as with an acrylic finish.	Colors are very uniform, but may fad over time. Some darker colors may fade faster tlan others.
Fire Resistance	Contributing to 1/8 inch ( 3 mm) to required 7/8 thickness of portland cement plaster for fire resistance.	Adds no resistance, rating achieved through increased 7/8" base coat.
Material Costs	Lower initial material costs than acrylic finish.	Higher initial material costs than cemenitious finish
Hairline Cracking	Hairline cracking transferring from base coat is not uncommon.	Good crack resistance, transferred bae coat cracks very low or much less than cementitius finish.
Color Matching	Good color matching.	Excellent color matching.
Regular Maintenance	Little maintenance required. Can be routinely washed.	Little maintenance required. Can be nutinely washed.
Repair Maintenance	Less expensive to replace or upgrade. Lower refurbish/ repair/material costs than acrylic finish.	More expensive to replace or upgrad. Higher refurbishing! repair costs in comparison to cementitious finish.
Crack Resistance Underlayment	Finish is rigid because of the cementitious chemistry. Cementitious stucco finish is applied over a cementitious base coat.	Finish is flexible due to the acrylic chimistry. Acrylic Finish is applied over a comenitious base coat or as the topcoat of EIFS.
Life Cycle	Jobs have performed for over 50 years without repair or recoating.	Jobs have performed for over 30 year without repair or recoating.

QUARTZ OR GRANITE HARD SURFACE COUNTERTOP

VARIATION OF COLOR EARTH-TONE CHOICES



	L			Ľ	_	i	ž	DES	
	THE DRAWINGS, DESIGNS, AND INFORMATION PROVIDED IN THESE	PLANS ARE THE EXCLUSIVE PROPERTY OF RECHARGS DESIGN GROUP AND ANDREW I SCHARDS. THE INCOMMETEN SHOWING	CONFIDENTIAL TO ALL RECEPTENTS AND NO PART OF THESE PLANS	MAY BE COMED, TRANSFERRED, OR REPRODUCED METHOUT THE WAITTEN CONSENT OF ANDREW A RICHARDS. THESE PLANS ARE	INTENDED FOR THE SOLE PURPOSE OF THE OWNER NOTED BELOIS.	NOTICE:	IT IS THE CLEAT'S RESPONSIBILITY PRICE TO AND DURING	OF ANY PERCEIVED ERRORS, ORESIGONS, OR DESCREPANCES PRICE	TO PROCEEDING WITH WORK.
	LABLE	REVISED BY							
	ISION TABLE	11							

DRAWINGS PROVIDED BY   REFERENCE   REFER			
AWINGS PROVIDED BY:  HARDS DESIGN GROUP    A.R   A.R   A.R   A.R   A.R			
ALR	DR	AWINGS PROVIDED BY:	
AJR AJR AJR	RIC	鱼	DATE:
AJR AJR AJR	ER:		11/11/202
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AJR	BY:	AJR	11/11/202
AJR	ED BY:	AJR	11/11/202
	/ED BY:	AJR	11/11/202

	DRAW	VINGS PROVIDED BY:	
Ī	RICHA	ARDS DESIGN GROUP	
T	ENGINEER:		
	DESIGNED BY: A	YJR	
5	DRAWN BY: A	\JR	
001	CHECKED BY: A	\JR	
3	APPROVED BY: A	AJR.	

191-200-028	HORIZONTAL CONTROL:	E. Schedules	DUNCAN GARDENS CONDO UNITS	ADDRESS: 4321 DUNCAN AVENUE, RIVERSIDE, CA 42503
APN#:	VERTICAL/	SHEET TITLE:	PROJECT:	ADDRESS:

DATE: 11/11/2022

SCALE: SHEET NO.:

SCH

ALL EXTERIOR GLAZING SHALL BE MULTI-PANE UNITS WITH MINIMUM OF ONE TEMPERED PANE

ALL EXTERIOR DOORS TO BE 20 MIN. RATED WITH CLOSURE

TEMPERED GLAZING SHALL BE PROVIDED IN THE FOLLOWING LOCATIONS:

- A. GLAZING IN ALL DOORS
- B. GLAZING IN BATH AND SHOWER
- C. GLAZING WITHIN A 24" ARC OF A DOOR EDGE
  D. PANELS OVER 9 SQUARE FT. HAVING THE LOWEST EDGE LESS
  THAN 18-IN. ABOVE THE FINISH FLOOR AND HAVING A TOP EDGE GREATER THAN 36-IN. ABOVE THE FLOOR
- E. ALL GLAZING 5 FT. FROM TOP OR BOTTOM OF STAIRWAYS WITH BOTTOM EDGE LESS THAN 60-IN. ABOVE WALKING SURFACE



SPECIFICATIONS OF WELLINGTON DRY STACK EARTH PANEL:

INTERIOR USE:HIGHLY DURABLE, INCREASES R-VALUE



MODEL:M3-D5-PN-EA LINE:WELLINGTON STYLE:DRY STACK COLOR:EARTH TYPE:PANEL EDGE TYPE:INTERLOCKING FIRE RATING: FIRE RATED POLYURETHANE AVAILABLE FOR EXTRA CHARGE PRODUCTION TIME:QUICK SHIP - APPROX. 1 TO 3 DAYS STANDARD - APPROX. 2 TO 3 WEEKS MATERIAL:POLYURETHANE OVERALL DIMENSIONS:48 %" WIDE x 25 %" HIGH x APPROX. 1 %" THICK COVERAGE DIMENSIONS:43 1/2" MIDE x 24" HIGH COVERAGE:APPROX. 7.25 SQ. FT. WEIGHT: APPROX. 7 LBS 10 OZ EACH PANEL SUGGESTED AMOUNT OF CAULK / GLUE:1 TUBE PER 4 PANELS EXTERIOR USE:WEATHER PROOF, NEAR ZERO UV DEGRADATION



CABINET SPECIFICATIONS: DOOR: BIRCH DOOR STYLE: RAISED OR REVERSE RAISED PANEL FINISH: GLAZED ON COG & AM; PAINT ON MS, MM, CC, HS, MC, BE FACE FRAME: BIRCH DRAWER FRONT: BIRCH BOX MATERIAL: 1/2" CABINET GRADE PLYMOOD