

GENERAL NOTES

- JS & ASSOCIATES SHALL IN NO WAY ASSUME RESPONSIBILITY FOR THE ELECTRICAL DESIGN OF THIS PROJECT. JSA LIGHTING DESIGN SHALL BE INCORPORATED AND VERIFIED BY ELECTRICAL ENGINEER OF RECORD FOR COMPLIANCE WITH ALL EGAL, INDUSTRY, AND PROJECT-SPECIFIC REQUIREMENTS & STANDARDS INCLUDING WITHOUT LIMITATION OF THE
- 1.1. 1.2.
- ALL APPLICABLE SPECIALTY CODES INCLUDING THE MOST CURRENT ISSUES & SUPPLEMENTS.
- 1.3. THE PROJECT MANUAL AND ASSOCIATED SPECIFICATIONS.
- 2. WHEN INTERPRETING THESE DRAWINGS, THE FOLLOWING GENERAL RULES APPLY:
- WRITTEN DIMENSIONS SHALL TAKE PRECEDENCE OVER SCALED DRAWINGS. SCALED DIMENSIONS SHOULD BE CONSIDERED ONLY APPROXIMATE. IT IS THE READER'S RESPONSIBILITY TO VERIFY & FIELD-MEASURE DIMENSIONS BEFORE PROCEEDING WITH ANY AFFECTED PROCUREMENT, FABRICATION OR CONSTRUCTION.
- SPECIFIC NOTES & DETAILS SHALL TAKE PRECEDENCE OVER GENERAL NOTES & TYPICAL DETAILS.
- WORK NOT PARTICULARLY SHOWN OR SPECIFIED SHALL BE THE SAME AS SIMILAR PARTS THAT ARE SHOWN & SPECIFIED
- PLANS ARE CONSIDERED DIAGRAMMATIC IN NATURE & INTENDED ONLY TO DEMONSTRATE THE RELATIONSHIP AMONG COMPONENT PARTS, AND NOT TO DEPICT
- WORK SHOWN AS "NIC" OR "NOT IN SCOPE" IS FOR REFERENCE ONLY.

RECESSED FIXTURE - ROUND

RECESSED FIXTURE - SQUARE

LED TAPE LIGHT / RIBBON LIGHT

LINEAR PENDANT FIXTURE

LINEAR RECESSED FIXTURE

WALL-MOUNTED STRIP LIGHT

ELECTRIC BACKLIT MIRROR

POLE-MOUNTED LIGHT HEAD

WALL MOUNTED. LOWER EXIT SIGN

SHADED REGION INDICATES FACE

CIRCUITING LIGHTING CIRCUIT: ON/OFF LIGHTING CIRCUIT: 0-10V DIMMING

CONDUCTORS IN CABLE WHERE APPLICABLE - \ LIGHTING CIRCUIT IN UNDERGROUND CONDUIT LIGHTING CIRCUIT HOMERUN OR ZONE CONTROL SYSTEM. 'Z#' INDICATES CONTROL ZONE NUMBER *ALL WIRING IS DIAGRAMMATIC ONLY. REFER TO MANUFACTURER WIRING INSTRUCTIONS AND PRODUCT DATA FOR MORE INFO.

SQUARE CANOPY LIGHT

SPOTLIGHT / UPLIGHT IN-GROUND WELL LIGHT

WALL-MOUNTED FIXTURE

2x2 LAY IN FIXTURE

2x4 LAY IN FIXTURE

RECESSED WALL WASH FIXTURE - ROUND

HATCHING INDICATES EMERGENCY FIXTURE

LIGHT BOLLARD (ARROW INDICATES DIRECTION)

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3. ELECTRONIC VERSIONS OF THESE PLANS ARE SUBJECT TO THE SAME PROVISION AS OTHER INSTRUMENTS OF SERVICE PREPARED BY OR ON THE BEHALF OF JS & ASSOCIATES, INCLUDING WITHOUT LIMITATION THEIR COMMON LAW, STATUTORY OR OTHER RESERVED RIGHTS, INCLUDING COPYRIGHTS. A RECIPIENT IS GRANTED AT MOST A TRANSFERABLE, RIGHTS, INCLUDING COPYRIGHTS, A RECPIEP IN IS GRANTED AT MOST A TRANSFERBALE, NO-MEXCLUSING LOCENET OF REUSE HE PLANS SOLE LYFE FOR PROLECT PURPOSES, AMD NO RECPIEPED IS AUTHORIZED TO USE OR TO ALLOW THE USE OF ALL OR ANY PORTION OF THESE PLANS FOR ANY OTHER PURPOSE. OF ALLOW THE USE FOR ANY OTHER PURPOSE COULD CONSTITUTE ACTIONALE PLAGMARISM. ANY ELECTRONAL DOCUMENTS WILL BE PROPOSED OF THE RESPONSIBILITY OF THE PROPOSED OF THE PROPOSED OF THE PROPOSED OF THE RESPONSIBILITY OF THE PROPOSED OF THE P OR CONVERSION TO THE OTHER FORMS OR CONVENTIONS, OR THE USE WILL PARTICULAR SOFTWARE OR HARDWARE, IS AT THE RECIPIENT'S SOLE RISK.

ELECTRICAL SYMBOLS LEGEND

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OCCUPANCY SENSOR

PANELBOARD

WALL SWITCH

LIGHTING INVERTER

DUPLEX RECEPTACLE

1/2 HOT DUPLEX RECEPTACLE

ELECTRIC BATHROOM EXHAUST FAN

INDICATES PLUG-IN LIGHT FIXTURE

LESMILEH
STANDARD WALL ON/OFF SWITCH
OCCUPANCY SENSOR
THREE WAY
THREE WAY
TAMPER-PROOF OR KEY OPERATED
ROOM CONTROLLER ON/OFF
ROOM CONTROLLER ON/OFF
ROOM CONTROLLER ON OFF
ROOM CONTROLLER 18 BUTTON (NO LOAD)

ROOM CONTROLLER: 8 BUTTON (NO LOAD)

INDICATES VIEW # ON SHEET LTG-#.#

PHOTOCELL (DAYLIGHT HARVESTING)

POWER PACK: RECEPTACLE LOAD CONTROL

POWER PACK: ON/OFF RELAY

POWER PACK: PHASE DIMMING

- WHERE ITEMS SHOWN ON THESE DRAWINGS SUCH AS LIGHTS, RECEPTACLES, ETC. ARE TO PENETRATE ANY BUILDING CELLINGS, WALLS, STRUCTURAL FYRAMING, ETC. IT IS REQUIRED HART AN APPROPRIATE Y SIZED OPENING OR CLEARANCE BE PURINSHED. THE CONTRACTOR SHALL COORDINATE THE INSTALLATION OF ALL ITEMS WITH THE CONSTRUCTION DOCUMENTS FROM TO THE MISTALLATION OF ANY ELECTRICAL WORK.
- 5. LIGHTING FIXTURES:
- LIGHTING FIXTURES SPECIFIED IN THESE DRAWINGS SHALL NOT BE SUBSTITUTED WITHOUT THE EXPRESSED AUTHORIZATION OF AN APPROPRIATE OWNER 5.1.
- LIGHTING FIXTURES & CONTROLS SHALL BE DELIVERED TO THE SITE IN NEW CONDITION
- ALL EXIT SIGNS & EMERGENCY LIGHTING SHALL COMPLY WITH UL 924 AND OPERATE FOR A MINIMUM OF 90 MINUTES IN EMERGENCY MODE.
- ALL LIGHTING FIXTURES SHALL BE UL OR ETL LISTED AND HAVE APPROPRIATE LABORATORY TESTING.
- ALL MEASUREMENTS, HEIGHTS, BACKGROUNDS, FINISHES SHALL BE VERIFIED BY INTERIOR DESIGNER AND ARCHITECT OF RECORD.

DIMENSIONS:

- 7.1. UNLESS OTHERWISE NOTED OR INDICATED, ALL DIMENSIONS ON THESE DOCUMENTS SHALL BE TO FACE OF CONCRETE OR MASONRY, FACE OF FINISH, OR CENTERLINE OF GRIDS.
- UNLESS OTHERWISE NOTED OR INDICATED, ALL VERTICAL DIMENSIONS ARE FROM FINISH FLOOR.
- DIMENSIONS SHOWN IN FIGURES TAKE PRECEDENCE OVER DIMENSIONS SCALED FROM DRAWINGS. LARGE-SCALE DRAWINGS & DETAILS TAKE PRECEDENCE OVER SMALLER-SCALE DRAWINGS.

(E)

(F) FUTURE

(N)

AC

AFG

BLG

BOD

COD

CU COPPER

GEC

GES

GFCI

GND

MC

NL

TYP UON

UTW

RELOCATED

ABOVE FINISH FLOOR

ABOVE FINISH GRADE

BOTTOM OF DEVICE

GROUNDING ELECTRODE CONDUCTOR

GROUND FAULT CIRCUIT INTERRUPTER

GROUNDING ELECTRODE SYSTEM

MECHANICAL CONTRACTOR

UNLESS OTHERWISE NOTED

UNSHIELDED TWISTED PAIR

NIGHT LIGHT

TRANSFORMER

ABBREVIATIONS

LIGHTING CONSULTANT	
JSA	
JS & ASSOCIATES	

535 PRINCELAND COURT CORONA CA 92879 P: 951.340.2475 JSASSOCIATESINC.COM

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NEW DRIVE-THRU PAD BLDG

C of E. ALESSANDRO BLV & SAN GORGONIO DR. RIVERSIDE, CA

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	DATE	2022.07.01			

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SHEET NO.	SHEET TITLE	2
LTG-0.1	SHEET INDEX, NOTES, ABBREVIATIONS & SYMBOLS	•
LTG-1.0	SITE LIGHTING PLAN	•
LTG-1.1	SITE PHOTOMETRICS	•
LTG-2.1	EXTERIOR LIGHTING FIXTURE CUTSHEETS	1


PRELIMINARY CONSTRUCTION

CHECKED BY: SCALE: AS SHOWN

HEET TITLE SHEET INDEX ABBREVIATIONS

& SYMBOLS LTG-0.1

PR-2022-001254 (CUP,DR) - Exhibit 8 - Project Plans

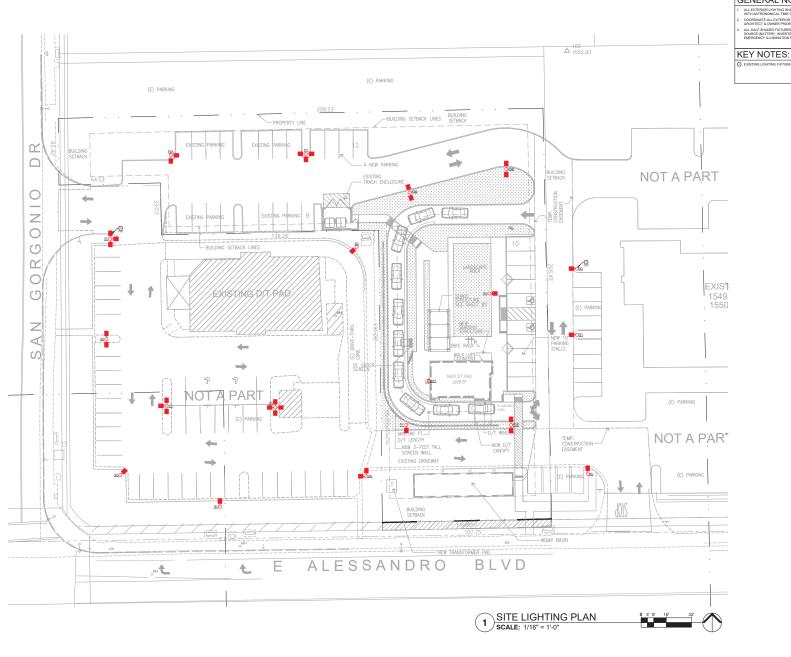

GENERAL NOTES:

 ALL EXTERIOR LIGHTING SHALL BE CONTROLLED VIA LIGHTING CONTROL PANE WITH ASTRONOMICAL TIME CLOCK.

COUNTRY ALL EXTERIOR LIGHTING FIXTURE MOUNTING HEIGHTS WITH

ALL HALF-SHADED FIXTURES SHALL BE CONNECTED TO AN EMERGENCY P
 SOURCE (BATTERY, INVERTER, OR GENERATOR) IN ORDER TO PROVIDE
 EMERGENCY II. LIMINATION LODG. A MINIMUM TO SO A MINIMUM

EXISTING LIGHTING FIXTURE ON ADJACENT PARCEL. NOT IN SCO

JS/ JE & ASSOCIATIES

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GRANS

ATMAN KADAKA

GREENS

8815 RESEARCH DRIVE

IRVINE, CA 92518

P: 949.322.1760

ECT:

NEW DRIVE-THRU PAD BLDG

NEC of E. ALESSANDRO BLV & SAN GORGONIO DR. RIVERSIDE, CA



PRELIMINARY




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SHEET TITLE:

SITE LIGHTING PLAN

LTG-1.0



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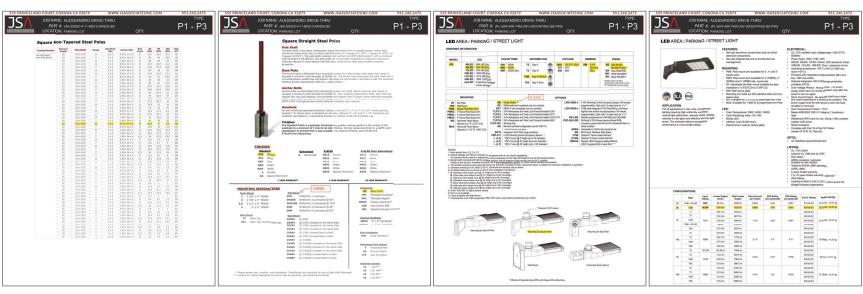
GR == NS ATMAN KADAKIA GREENS 8815 RESEARCH DRIVE IRVINE, CA 92618 P: 949.322.1760

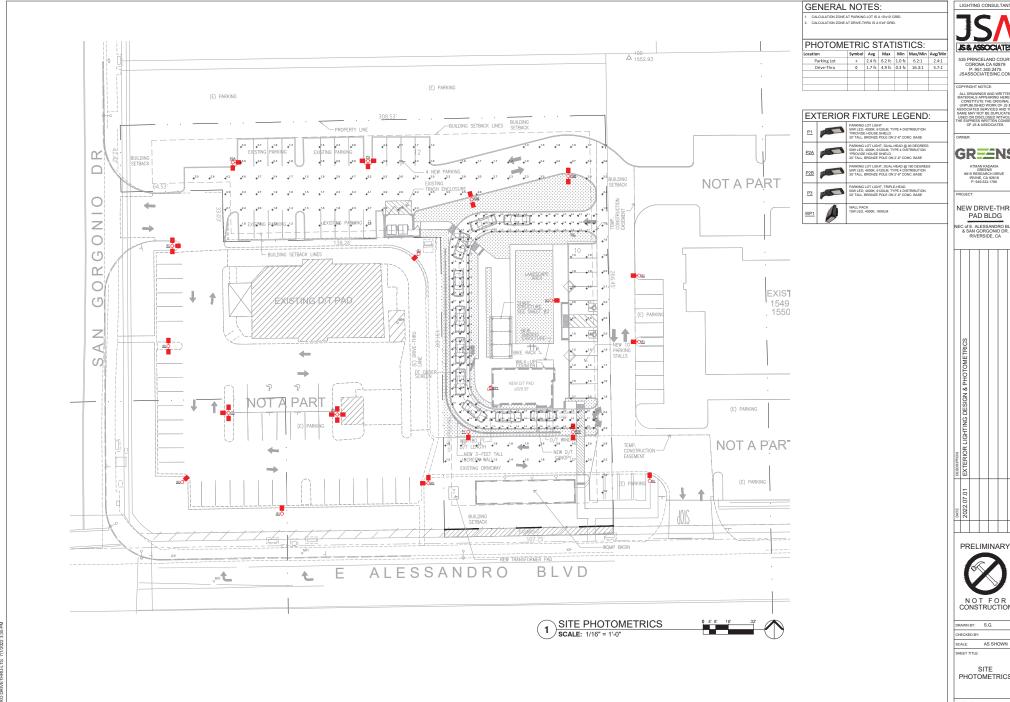NEW DRIVE-THRU PAD BLDG


EC of E. ALESSANDRO BL' & SAN GORGONIO DR. RIVERSIDE, CA

CHECKED BY: AS SHOWN

PHOTOMETRICS




FIXTURE TYPES 'P1', 'P2A', 'P2B', & 'P3'

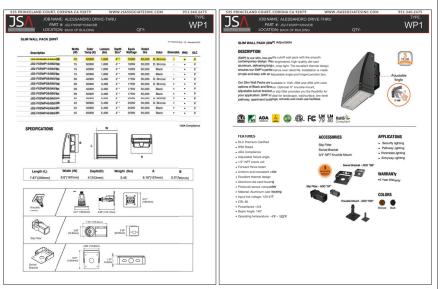

GR==NS ATMAN KADAKIA GREENS 8815 RESEARCH DRIVE IRVINE, CA 92618 P: 949.322.1760 NEW DRIVE-THRU PAD BLDG EC of E. ALESSANDRO BLV & SAN GORGONIO DR. RIVERSIDE, CA **PRELIMINARY** CHECKED BY: SCALE: AS SHOWN EXTERIOR LIGHTING FIXTURE CUTSHEETS LTG-2.1

DRO DRIVETHRU-LTG 7/1/2022 3:35 F

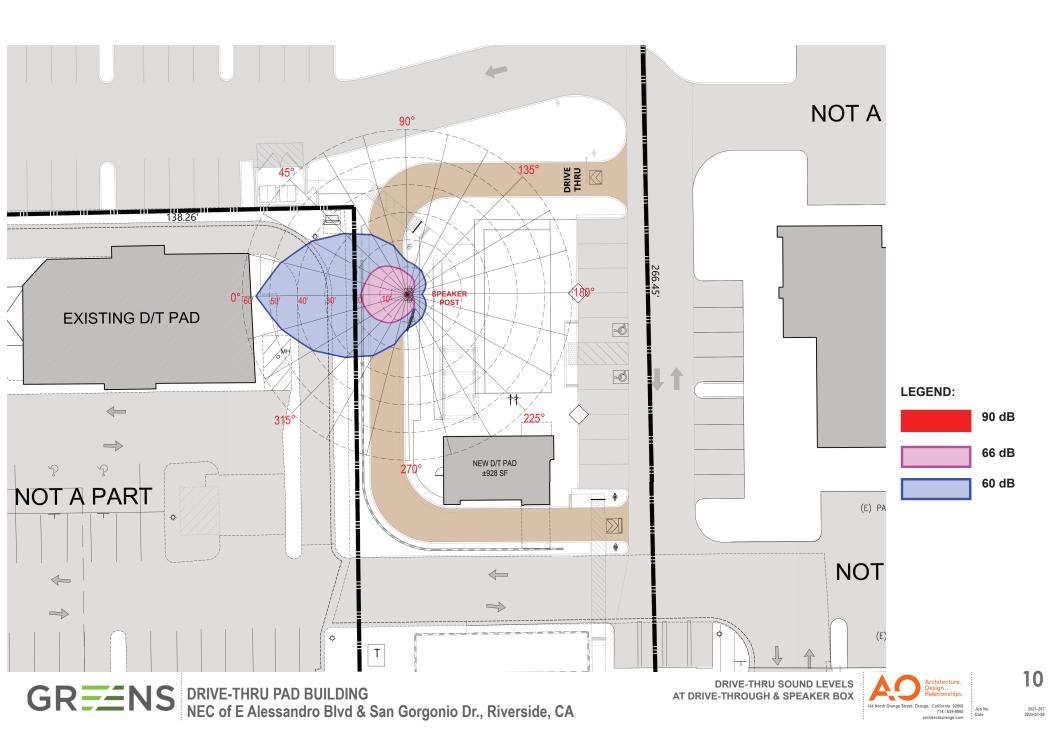



Project Narrative Alessandro & San Gorgonio Drive Thru PR-2022-001254 APN: 263-250-069

Background:

The project site is located within the City of Riverside, APN: 263-250-069. The parcel currently has an undeveloped pad and existing parking stalls on the northside of the parcel. Adjacent uses include the business and manufacturing parks to the north, sit down/drive thru (Farmer Boys Restaurant) to the west, undeveloped land to the south; and office uses (Riverside County Office of Education) to the east. The project site's frontage is on the northern side of East Alessandro Blvd, eastern side of San Gorgonio Drive, west side of the 215 Freeway.

Drive-Thru:

The proposed development is a 928 SF Drive-Thru only building which sites on an approximately .96-acre site. The drive-thru features an approximate 12-car queue and enhanced landscape screening. The development will be serviced by an existing double bin trash enclosure that is situated at the north portion of the parcel. The building will have a walk-up window with ample shade structures, the development will have no in-door seating or dining available.

Hours of Operation:

7 days a week, 4:30 am to 10:00 p.m.

Employees:

2 daily shifts with 4 employees each.

Parking:

A total of 31 parking spaces would be provided as a part of the Proposed Project.

Demolition & Construction:

The construction will be a single-phase construction with an anticipated schedule of 5-6months. Construction is anticipated in Q-4 of 2022 and completion by June 2023.