

Exhibit 2 - P17-0015, Zoning


Exhibit 3 – Photos



Existing Property




Facade of Existing Residence

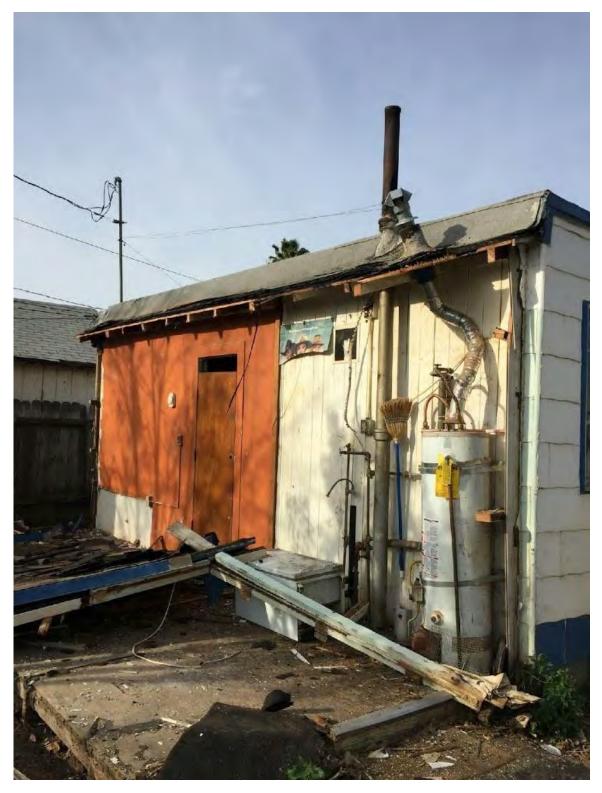


Rear Elevation of Existing Residence

New Room Addition / Renovation

4258 Larchwood PI. Riverside, CA 92506

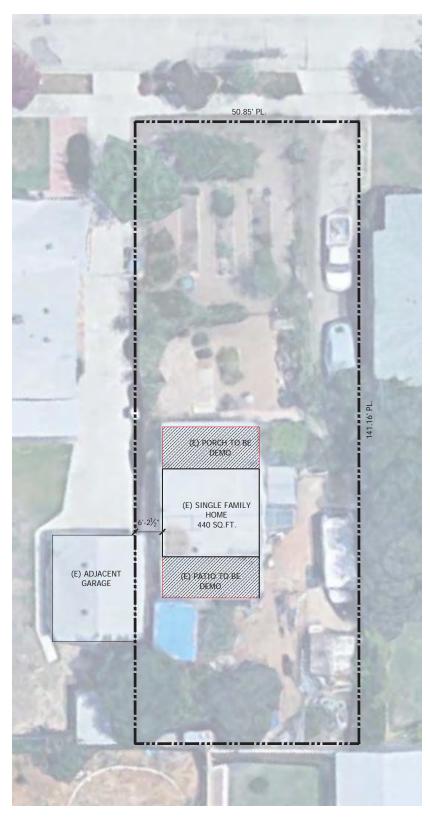

EXISTING PLOT PLAN SCALE: 1" = 10'-0"

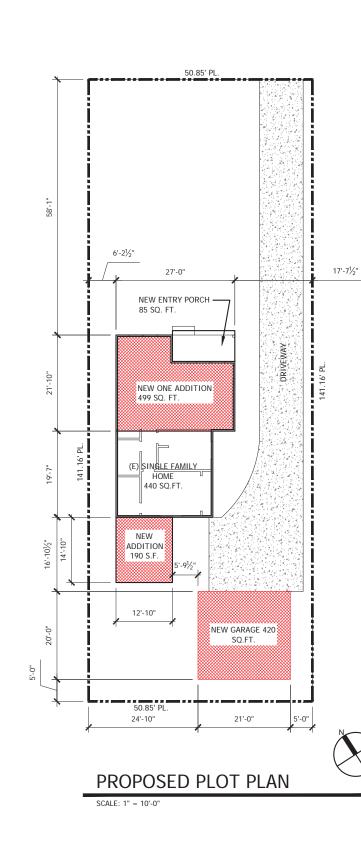

Project Areas

EXISTING LIVING AREA SQ. FOOTA NEW ADDITION AREA SQ. FOOTAG TOTAL LIVING AREA SQ. FOOTAG NEW ENTRY PORCH NEW GARAGE AREA SQ. FOOTAGE	GE 689 E 1129 85	SQ. FT SQ. FT SQ. FT SQ.FT. SQ. FT
TOTAL BUILDING AREA LOT SIZE:		SQ. FT. SQ. FT
TOTAL LOT COVERAGE	23%	
Draigat Data		

Project Data

ZONING INFO:	
BUILDING ZONE	R1-7000
OCCUPANCY	R-3 , GROUP U
CONSTRUCTION TYPE	V-B
FIRE SPRINKLER REQ.	NO
COUNTY	RIVERSIDE
CITY	RIVERSIDE
NUMBER OF STORIES	1 STORY
LEGAL DESCRIPTION	Lot 43 MB 008/072 DR BOGUE TR

A.P.N.: LOT SIZE: YEAR BUILT 217182016 6969 SQ. FT. ± 1920

Contact Info

Contractor: Mike Cote 951.823.7148

Structural Engineer: N. Skaf Consultant 411 Green Orchard Pl. Riverside, CA 92506 Tel: 951.522.2837

Designer Xavier Design Group 4481 Pondmoor Dr. Riverside, CA 92505 Contact: Xavier Hernandez Tel: 951.830.2018 xavier@xavierdesigngroup.com

T24 Consultant Xavier Design Group 4481 Pondmoor Dr Riverside, CA 92505 Contact: Xavier Hernandez Tel: 951.830.2018 xavier@title24consultants.net





Exhibit 4 - P17-0015, Plans

XAVIER DESIGN GROUP

4481 Pondmoor Dr

Riverside California 92505 951 830 2018

Project Description

To build an attached room addition which consist of a new kitchen, dining and living room. Existing residence to be completely renovated to include two bedrooms and two bathrooms

Drawing Index

SHEET	SHEET TITLE
CS	COVER SHEET + SITE PLAN
A1	FLOOR PLANS
A2	BUILDING ELEVATIONS
A2.1	COLORED ELEVATIONS

Site Plan Notes

- 1. FINISH GRADE AROUND THE NEW STRUCTURE / ADDITION SHALL BE SLOPED AWAY FROM THE BUILDING FOR DRAINAGE PURPOSES.
- INSTALLATION CERTIFICATES, OPERATING INFORMATION MAINTENANCE INFORMATION, AND VENTILATION INFORMATION MUST BE PROVIDED TO THE BUILDING OWNER PRIOR TO FINAL INSPECTION
- 3. MANUFACTURER'S PRODUCT INSTALLATION INSTRUCTIONS SHALL BE AVAILABLE ON THE JOB SITE AT THE TIME OF INSPECTION.
- ALL APPLICABLE INSTALLATION 4 CERTIFICATES (CE-6R) FORMS AND CERTIFICATE OF FIELD VERIFICATION AND DIAGNOSTIC TESTING (CF-4R) FORMS SHALL BE COMPLETED AND POSTED AT THE PROJECT SITE TO BE VERIFIED BY THE BUILDING INSPECTOR
- A MINIMUM OF 50% OF THE NON-5 HAZARDOUS CONSTRUCTION WASTE GENERATED AT THE SITE SHALL BE DIVERTED TO RECYCLE OR SALVAGE

APPLICABLE BUILDING CODES:

2013 CALIFORNIA BUILDING CODE 2013 CALIFORNIA PLUMBING CODE 2013 CALIFORNIA RESIDENTIAL CODE 2013 CALIFORNIA ELECTRICAL CODE 2013 CALIFORNIA GREEN CODE 2013 CALIFORNIA MECHANICAL CODE 2013 CALIFORNIA ENERGY CODE

Javietter

Xavier Hernandez




Date

Cover Sheet + Site Plan

CS


WATER CLOSETS: SHOWER HEAD: FAUCETS/SINKS/LAVS: KITCHEN FAUCETS _____ (E) WALL WALLS TO BE DEMOLISHED

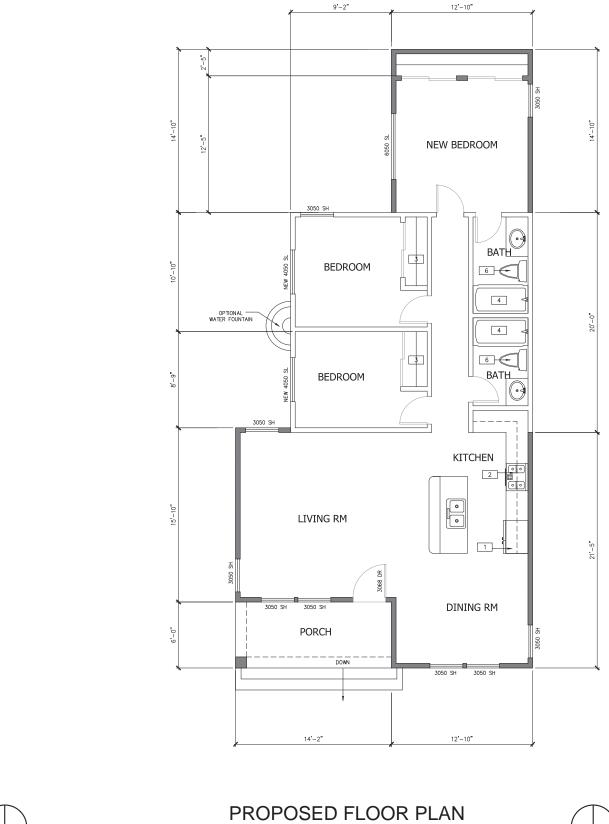

21'-0" 2-4 2668 DR. 2-6 ₽ G≓CI GARAGE 16'-0" X 7'-0" SECTIONAL GARAGE DR ₽ ₽ 2'-6" 16'-0" 2'-6" 21'-0"

> GARAGE FLOOR PLAN SCALE: 1/4" = 1'-0"

SCALE: 1/4" = 1'-0"

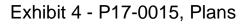

FLOOR PLAN KEYNOTES

- REFRIGERATOR SPACE, PROVIDE RECESSED COLD WATER BIB AND SHUT-OFF
- 2 RANGE/COOKTOP WITH 100 CFM MIN. HOOD, LIGHT AND FAN (VENT TO OUTSIDE AIR).
- 3 PAINT-GRADE WOOD OR VINYL-COATED WIRE, 12" DEEP SHELF AT 67" ABOVE FINISHED FLOOR.
- 32"X60" FIBERGLASS TUB AND SHOWER UNIT W/ MIN. 70" HIGH CEMENT PLASTER, CERAMIC TILE OR APPROVED EQUAL AT WALLS, PROVIDE CURTAIN ROD OR SAFETY GLASS ENCLOSURE. CONTROL VALVES TO BE PRESSURE BALANCED OR THERMOSTATIC MIXING VALVES.
- 5 200 AMP ELECTRICAL PANEL WITH MIN 20' UFER GROUND WITH BOND TO GAS AND WATER PIPING. CONDUCTORS SHALL HAVE A VERTICAL CLEARANCE ABOVE ROOFS OF NOT LESS THAN 3'-0".
- WATER CLOSETS SHALL HAVE 15" CLEARANCE TO ANY WALL OR
 OBSTRUCTION ON EACH SIDE OF ITS CENTERLINE AND 24" CLEAR SPACE IN
 FRONT.

SHEET NOTES

1. ALL WINDOWS TO BE DUAL GLAZE VINYL WINDOWS BY ANDERSEN MISSION REVIVAL 2. ALL EXTERIOR DOORS TO BE SOLID WOOD DOORS BY ANDERSEN MISSION REVIVAL

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FIXTURE FLOW RATES

1.28 GAL PER FLUSH 1.8 GAL PER MINUTE @ 60 PSI 1.5 GAL PER MINUTE @ 60 PSI 1.8 GAL PER MINUTE @ 60 PSI

WALL LEGEND

NEW WALL (2X4 STUDS @ 16" O.C.)




Revision

Date

Floor Plan



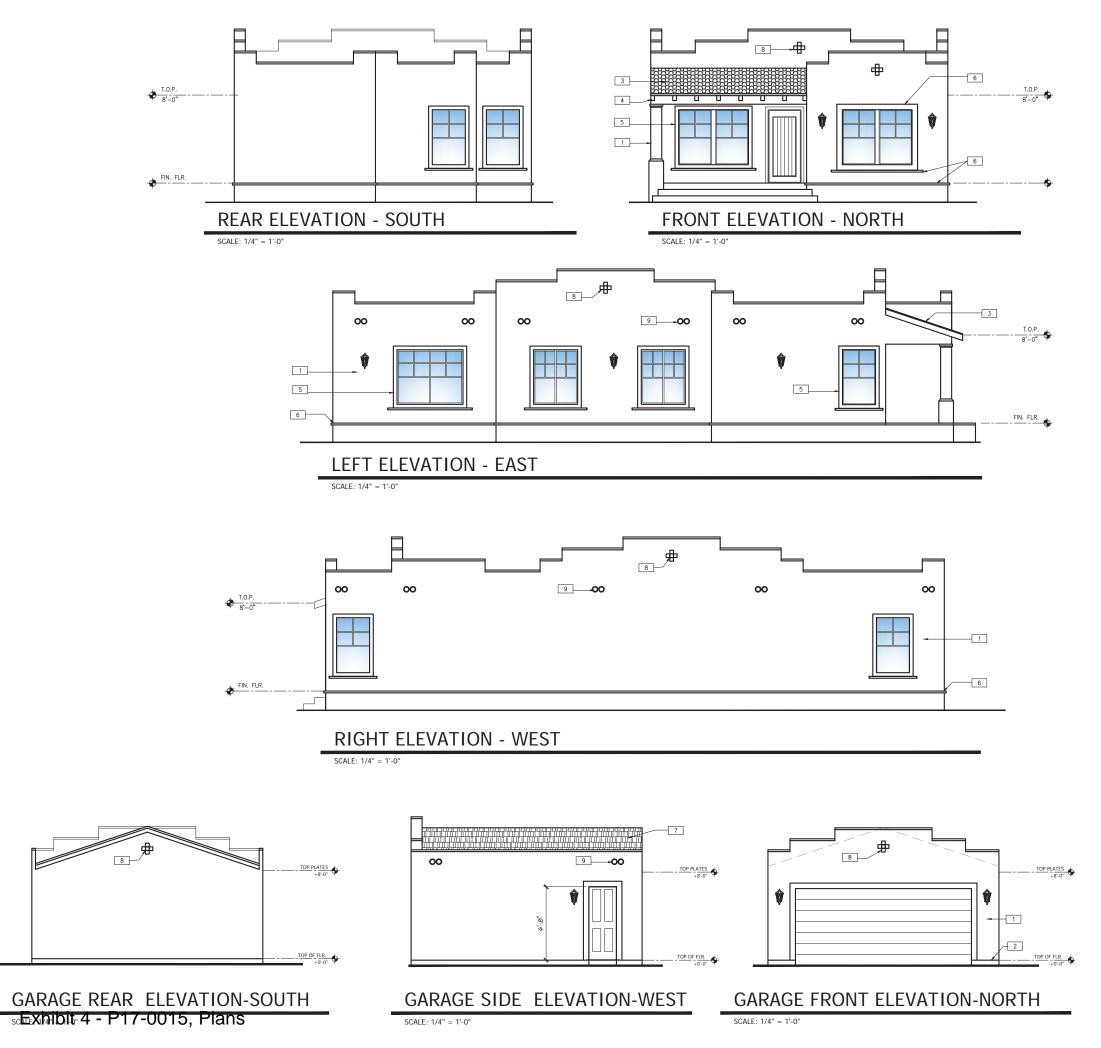

ELEVATION KEYNOTES

1 %" STUCCO FIN. O/ 2-LAYERS OF GRADE "D" PAPER, TO MATCH (E) A MIN. 26 GA. CORROSION RESISTANT OR PLASTIC WEEP SCREED WITH A MIN. VERTICAL FLANCE OF 3 ½" SHALL BE PROVDED AT OR BELOW FOUNDATION PLATE UNE ON EXTERNOR STUD MULLS. SCREED SHALL BE A MIN. OF 4" ABOVE EARTH OR 2" ABOVE PAVED AREAS.

3 TILE ROOF, 0/ 30# FELT 0/ ½" PLWD. SHEATHING ESR-1900.

- 4 DECORATIVE 4X WOOD CORBEL
- 5 DECORATIVE 4" WOOD TRIM, PAINTED
- 6 DECORATIVE WOOD TRIM. PAINTED
- 7 COMPOSITION ROOF, 0/ 30# FELT 0/ ½" PLWD. CLASS "A",TO MATCH (E) ESR #1475
- 8 DECORATIVE 6" SQ. CERAMIC TILES
- 9 6" ROUND CLAY TILE SCUPPERS

ELEVATION NOTES

APPROVED CORROSION RESISTANT FLASHING SHALL BE INSTALLED AT ALL THE FOLLOWING LOCATIONS.

EXTERIOR WINDOWS AND DOOR OPENINGS. FLASHING AT EXTERIOR WINDOW AND DOOR OPENINGS SHALL EXTEND TO THE SUBFACE OF THE EXTERIOR WALL FINISH OR TO THE WATER RESISTIVE BARRIER FOR SUBSEQUENT DRAINAGE.

AT THE INTERSECTION OF CHIMNEYS OR OTHER MASONRY CONSTRUCTION WITH FRAME OR STUCCO WALLS, WITH PROJECTING LIPS ON BOTH SIDES UNDER STUCCO COPINGS.

UNDER AND AT THE ENDS OF MASONRY, WOOD OR METAL COPINGS AND SILLS.

CONTINUOUSLY ABOVE ALL PROJECTING WOOD TRIM.

WHERE EXTERIOR PORCHES, DECKS OR STAIRS ATTACH TO A WALL OR FLOOR ASSEMBLY OF WOOD FRAME CONSTRUCTION.

AT WALL AND ROOF INTERSECTIONS. AT BUILT IN GUTTER.

WINDOW SILL HEIGHT IN THE BEDROOMS FOR EMERGENCY ESCAPE SHALL BE NOT MORE THAN 44" ABOVE FLOOR.



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Addition


New

Revision

4258 Larchwood Pl. Riverside, CA 92506

Date

"Exterior openings exposed to the weather shall be flashed in such a manner as to make them waterproof".

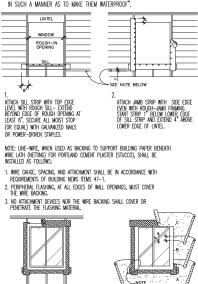

3. INSTALL WINDOW JAME NALING FLANGES OVER A CONTINUOS BEAD OF SEALANT ON THE MOIST STOP (OR EQUA). INSTALL THE WINDOW HEAD MOIST STOP (OR EQUAL) ON A CONTINUOS BEAD OF SEALANT APPLIED TO THE WINDOW HEAD NALING FLANCE

PAPER OVADER SILL SIMP. NOTE: CUT ANY EXCESS BUILDING PAPER THAT MAY EXTEND ABOVE THE SILL FLANGE LINE. DO NOT SILCE BUILDING PAPER HORIZONTALLY SO THAT PAPER WILL VAP OVER THE JAMB STRIPS. INSTALL SUCCESSIVE LINES OF BUILDING PAPER (JC.D.C.T.C.) OVER

BUILDING PAPER (B.C.D. ETC.) OVER JAMB AND HEAD FLANGERS, LAPPING EACH COURSE.


WINDOW FLASHING

4. COMMENCING AT THE BOTTOM (SOLE PLATE) OF THE WALL, LAY BUILDING PAPER UNDER SILL STRIP.





Building Elevations

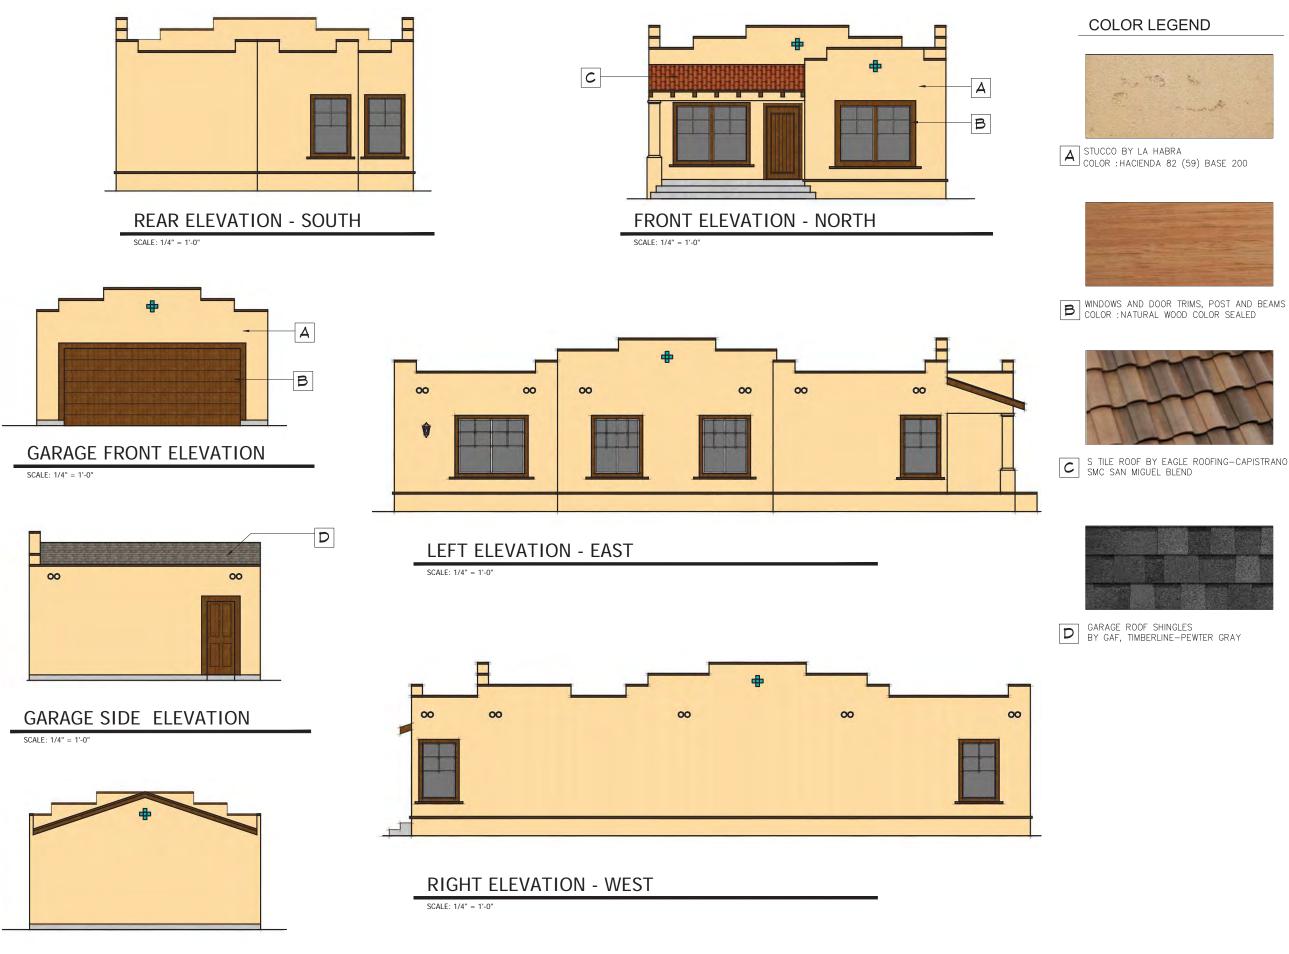

GARAGE SIDE ELEVATION Exhibit 4 - 017-0015, Plans

XAVIER DESIGN GROUP

4481 Pondmoor Dr Riverside California 92505 951 830 2018

Javietten

Xavier Hernandez



Building Elevations Color Board



From: Donna Estrada [mailto:donna.estrada@iapmortl.org]
Sent: Tuesday, June 27, 2017 8:05 AM
To: Watson, Scott
Subject: [External] 4258 Larchwood Place, Riverside, CA 92506

My name is Donna Estrada and I am the property owner of the home adjacent to the subject property on the west side.

I have no objections to the proposed updating of the subject property provided that some type of landscaping and fencing maintenance is also involved.

Currently I place the wooden fence that adjoins the property and I have not been allowed to maintain it by the current and former owners. In addition there is a tree adjoin the property in the from which is breaking down the chain link fence as well as my driveway. I was told this is a "historic" tree and it could not be removed. That tree was planted about 10 years ago.

I am hoping that the proposal will include addressing not only the house but the landscaping as well.

If you have any questions you may reach me at the telephone number or e-mail below.

Regards, Donna Estrada Senior Vice President, Lab Services and Administrative Direct Line (909) 472-4134 E-mail: donna.estrada@iapmortl.org