





GENERAL NOTES

| ABBREVIATIONS | | | | | | |
|---------------|---|---------------|--|--|--|--|
| A/C | Air Conditioning | LAV | Lavatory | | | |
| ACP AFF | Asphaltic Concrete Paving Above Finish Floor | LAM | Laminate | | | |
| ALL | Above Filiali Flooi | MAX | Maximum | | | |
| ALU | Aluminum | MECH | Mechanical | | | |
| ARCH | Architect(ural) | | Membrane | | | |
| | | M.E. | Manufacturer Finish | | | |
| BLDG | Building | MFR MIN | Manufacturer | | | |
| CI | Control Joint | MIN M.O. | Minimum Masonry Opening | | | |
| CLG | Ceiling | MTL | Metal | | | |
| CLR | Clear | mil | mean . | | | |
| COL. | Column | (N) | New | | | |
| CONC | Concrete | NIC | Not in Contract | | | |
| CONT | Continuous | NOM | Nominal | | | |
| CPT C.T. | Carpet Ceramic Tile | NTS | Not To Scale | | | |
| U.I. | Celanic ne | O.C. | On Center | | | |
| D.A. | Disabled Access | 0.D. | Outside Diameter | | | |
| D.F. | Drinking Fountain | O.H. | Opposite Hand | | | |
| DIA | Diameter | OPG | Opening | | | |
| D.S. | Downspout | OPP | Opposite | | | |
| DTL DWG | Detail | (P) | Paint | | | |
| DWG | Drawing | (P) PR | Paint | | | |
| (E) | Existing | PWD | Plywood | | | |
| ÉÁ | Each | | 1 tymoo | | | |
| EJ | Expansion Joint | QT | Quarry Tile | | | |
| ELEC | Electrical | | | | | |
| EL | Elevation | R | Riser | | | |
| EQ | Equal Equipment | (R) Re: | Remove Refer (to) | | | |
| EWC | Electric Water Cooler | REOD. | Required | | | |
| FXT | Exterior | RENE | Reinforced | | | |
| | | R.D. | Roof Drain | | | |
| F.D. | Floor Drain | R.O. | Rough Opening | | | |
| FDN | Foundation | | | | | |
| F.E. FFC | Fire Extinguisher Fire Extinguisher Cabinet | S.A.C. | Suspended Acoustical Celling Solid Core | | | |
| FF | Fire Extinguisher Cabinet Finish Floor | SE | Square Foot | | | |
| F.O.C. | Face of Concrete | SIM | Similar | | | |
| F.O.F. | Face of Finish | SPEC | Specifications | | | |
| F.O.S. | Face of Stud | SST | Stainless Steel | | | |
| F.R. | Fire-Retardant | STD | Standard | | | |
| FUR | Furring | STL | Steel Structural | | | |
| GA | Gauge or Gage | SUSP. | Suspended | | | |
| GALV | Galvanized | 0001. | Suspenioru | | | |
| GC | General Contractor | T | Tread | | | |
| GWB | Gypsum Wall Board | T.O.B. | Top of Beam - Steel | | | |
| GWB-MR | GWB Moisture Resistant | T.O.C. | Top of Concrete | | | |
| GWB-X | GWB Fire Rated "X" | T.O.S. | Top of Sheathing | | | |
| H.B. | Hose Bib | T.O.W. TYP | Top of Wall Typical | | | |
| HC. | Hollow Core | 1115 | турса | | | |
| HDWR | Hardware | 101 | Underwriters Laboratory | | | |
| H.M. | Hollow Metal | UNO | Unless Noted Otherwise | | | |
| HORZ | Horizontal | | | | | |
| HT | Height | VCT | Vinyl Composition Tile | | | |
| ID. | Inside Diameter | VER | Vertical | | | |
| I.D. INSUL | Inside Diameter Insulation | VWC | Vinyl Wall Covering | | | |
| INT | Interior | W | With | | | |
| | | WC | Water Closet | | | |
| JAN. | Janitor | WR | Water Resistant | | | |
| .IT | Joint | WWF | Welded Wire Fabric | | | |


Enterprise Car Sales


WOLF NEJEDLY V, LLC 7095 INDIANA AVENUE, SUITE 100 RIVERSIDE, CA 92506 951 . 686 . 7151

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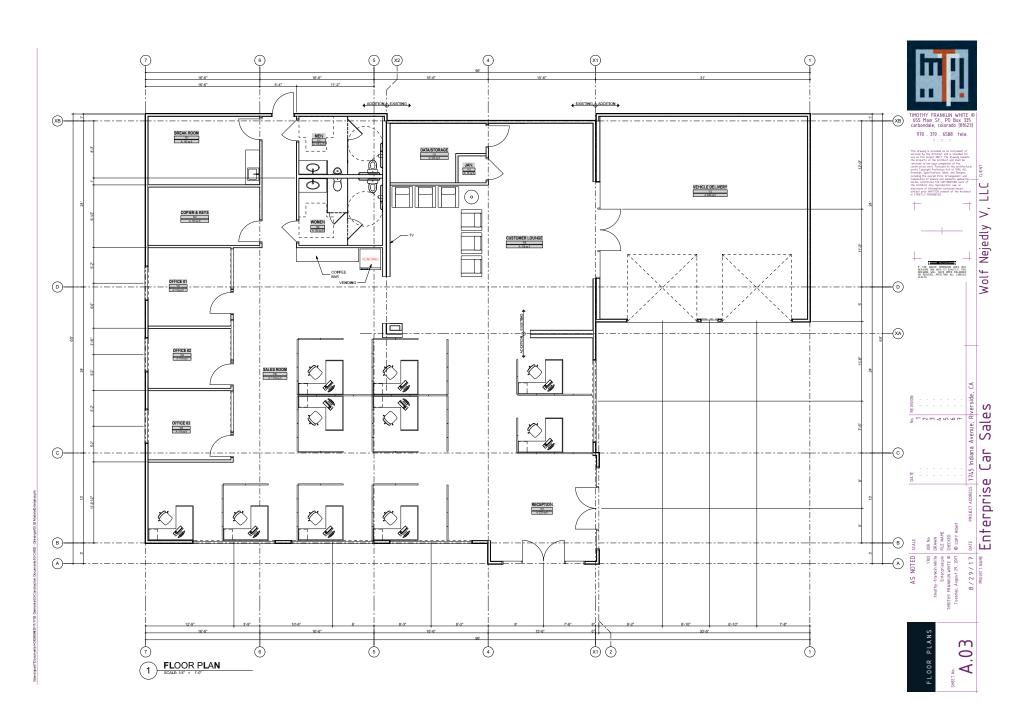







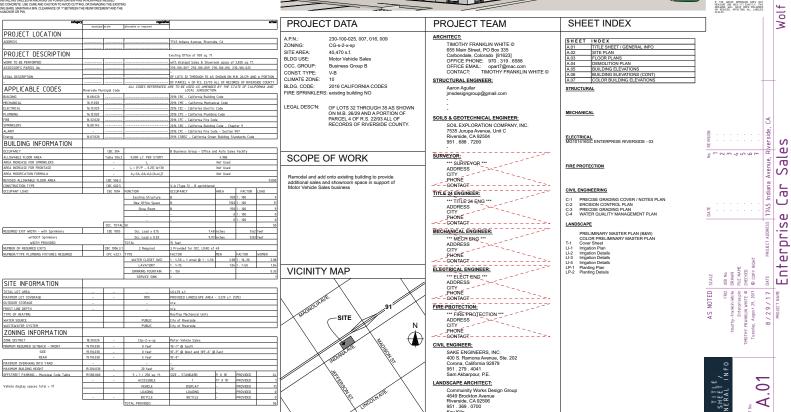

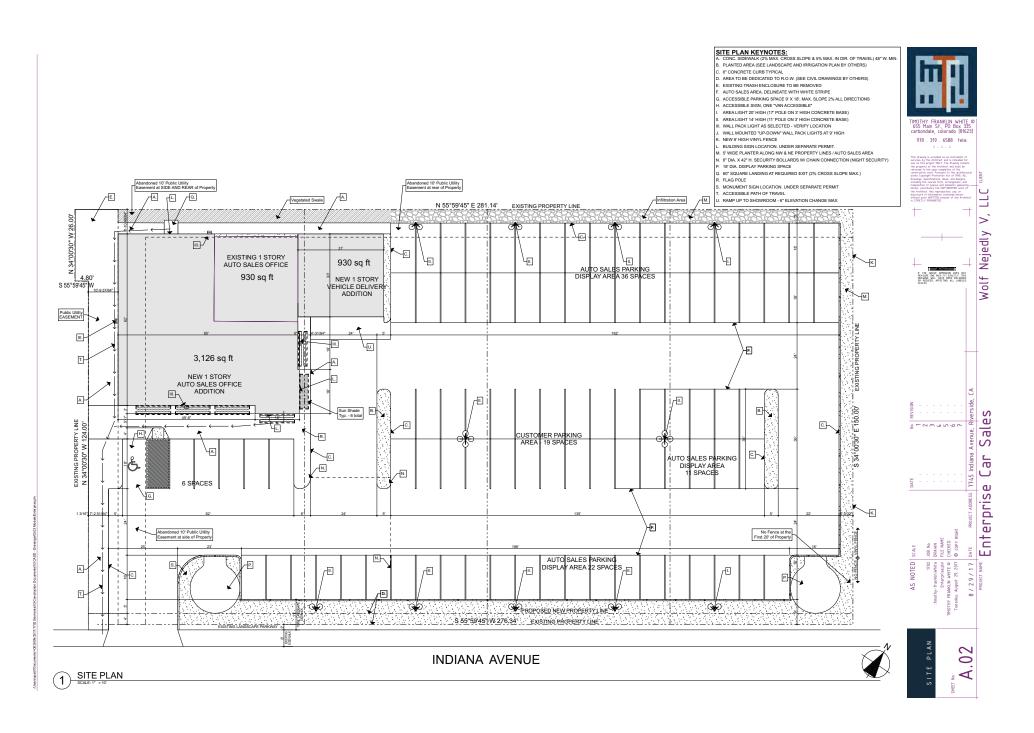
P16-0617, P16-0618 & P17-0609, Exhibit 7 - Project Plans




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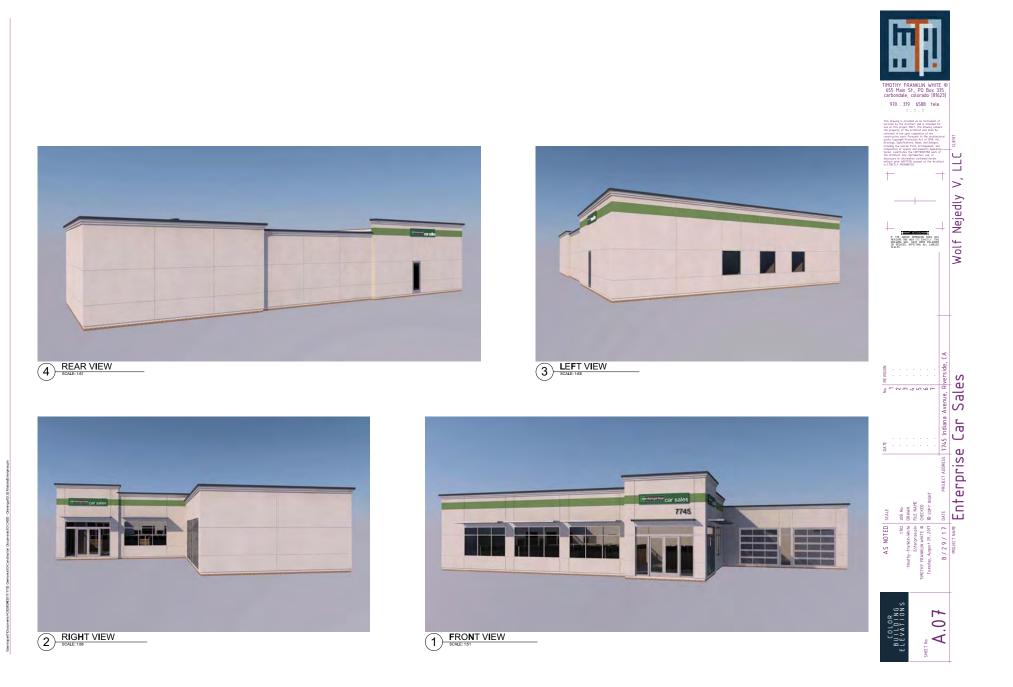
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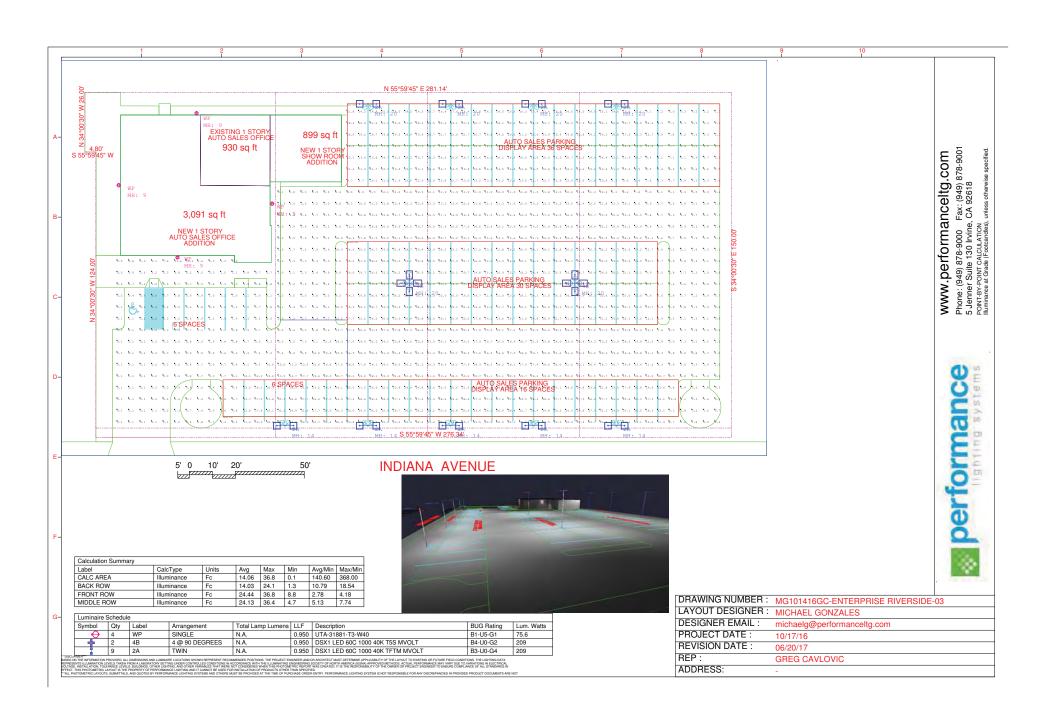

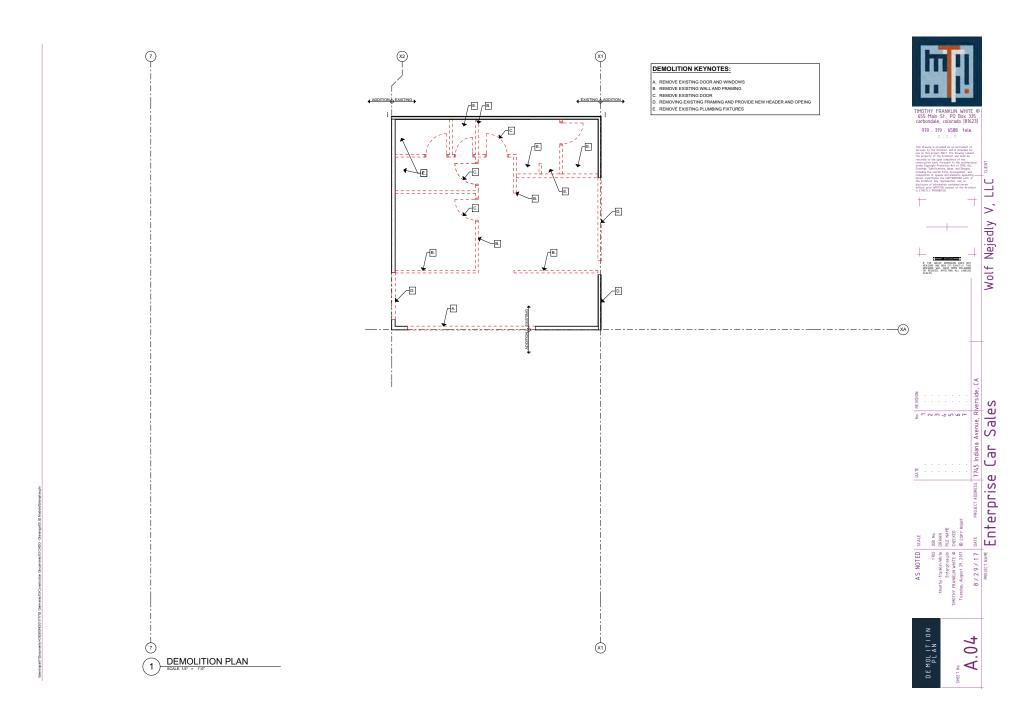
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GENERAL NOTES:

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1. ALL GOUDNOS SHALL CONFORM TO THE RIVERSOR MUNICIPAL COLE, TITLE 17 AND OF THE COLL. ALL GOUDNOS SHALL CONFORM TO THE RIVERSOR MUNICIPAL COLE, TITLE 17 AND OF THE PERMISSION OF THE PRESIDENCY OF THE PROSIDENCY OF THE PRESIDENCY OF THE PRESIDENCY OF THE PRESIDENCY
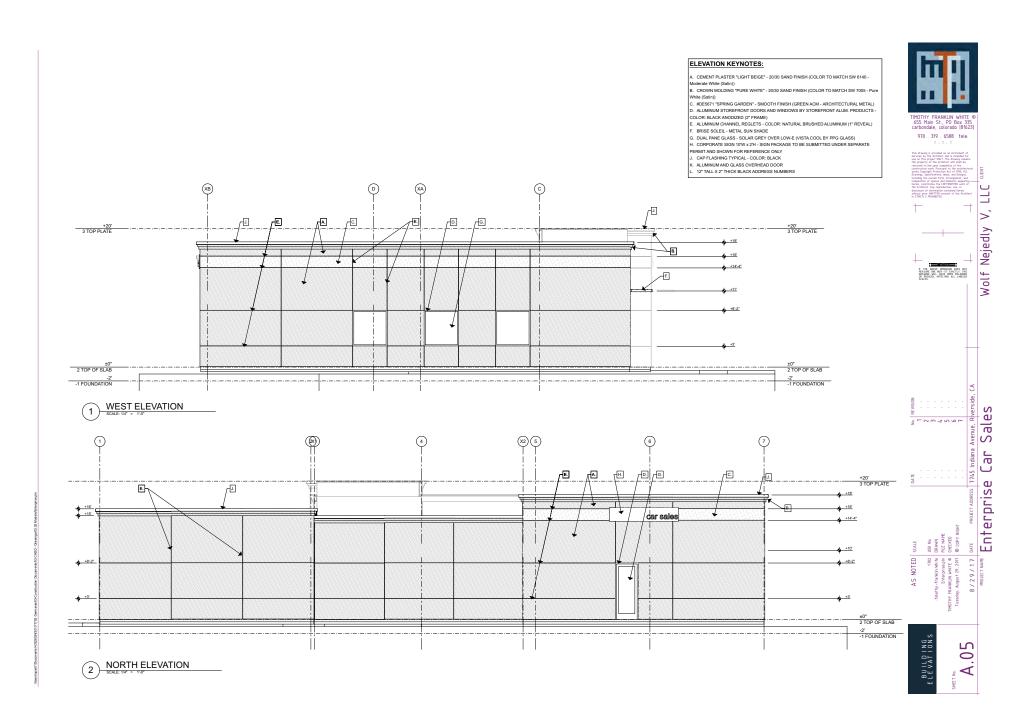
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REPRESENTATIVE OF THE REGIONAL WAIER QUALITY CONTROL BOARD (RINCER) — SANTA ANA REGION AND,OFF THE CITY OF RIVERSIDE. 12. GRADING OPERATIONS SHALL BE LUNITED TO BETWEEN THE HOURS OF 7 AM. AND 7 PM. ON WEEKCAM'S AND BETWEEN B AM. AND 5 PM. ON SATURDAYS. NO ORGANION WILL BE PERMITTED ON SUNDAY OR FEDERAL HOLIDAYS. (RIVERSIDE MUNICIPAL CODE, 7.35.010, ORDINANCE NO 6273)

NOTICE TO CONTRACTORS

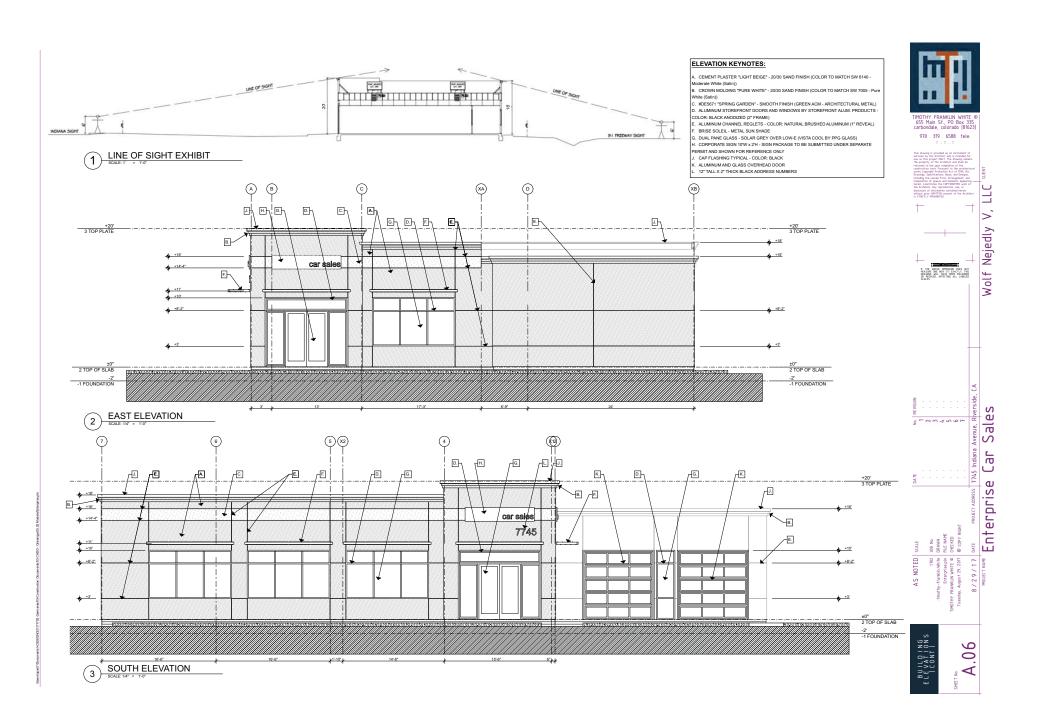CONNECTOR SALL POPULE AT THE TRE-W STATONS AND AT ANY OTHER POINTS OF POTENTIAL CONFLICTS WITH UNDERGROUND FACILITIES REFORE STATEMEN CONSTRUCTION. ENSTRUCT SUBSTRUCTION OF POTENTIAL CONFLICT MAY DESIRED THE ACCURACY WAR DEMANDS THE CONFLICT WAR DESIRES ARTHUR THE ACCURACY WAR DEMANDS THE CONFLICT WAS DEMAND. AND THE ACCURACY WAS DEMAND OF THE ACCURACY WAS DEMAND. AND THE ACCURACY OF ACCURACY WAS DEMAND. AND THE ACCURACY WAS DEMAND. AND THE ACCURACY OF ACCURACY OF THE AC


1. THE EXISTENCE AND LOCATION OF ANY UNDERGROUND UTLITY PIPES OR STRUCTURES SHOWN ON THESE PLANS OF THE FIRST OF THE CONTINUED OF MANABEL RECORDS. THESE CONTINUE ARE APPRICIABLE AND SHELL BE CONTINUED IN THE FIRED BY THE CONTINUED OF THAT ANY RECESSARY ADJUSTMENT ON BE MADE IN AUGMENT AND/OF GROUD OF THE PROPOSED MAPPENED. THE CONTINUED AS TO PRECIDE OF THE SHOWN OF THESE PLANS.

 CARE SHOULD BE TAKEN TO PREVENT GRADED DITCHES AND SWALES FROM UNDERMINING STREET IMPROVEMENTS.
 UPON INSPECTION OF THE SITES, THE CITY ENGINEER MAY REQUIRE TEMPORARY GUNITE SWALES, ENTERING OR 3. ALL AREAS SHALL SLOPE A MINIMUM OF 1.0% TO STREETS, DRIVE OR SWALE UNLESS OTHERWISE NOTED.

4. QUANTITIES SHOWN HERE ARE FOR PLAN CHECKING PURPOSES ONLY. CONTRACTOR IS RESPONSIBLE TO PERFORM OWN QUANTITIES TAKEOFF.

OF CONTROLLED HAVE BY HE SHALL ISSUE SOLL AND COMPLETE RESPONSEBILITY FOR ME SET CONTROLLED TO CONTROLLED HAVE A CONTROLLED TO SET CONTROLLED THE SET CONTROLLED THE SET OF ALL PROSEDS HAVE PROPERTY HAT THE REQUIREMENTS SHALL APPLY CONTROLLED AND HOT BE LANDED TO MEANL REPORTED CHARGE AND FED CONTROLLED AND HOT BE CONTROLLED AND HOT SET OF CONTROLLED AND HOT SHALL REPORT HAVE SET OF AN ART SHALL HAVE A CONTROLLED AND HOT SHALL REPORT HAVE SET OF ANY AND HAVE A REPORT HAVE



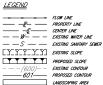

GRADE BREAM
HOF FORM
HOF FORM
DEVISION
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TH = TOP OF MALL


R = BADIS

BO = FOOTHER

B

CITY OF RIVERSIDE PRECISE GRADING PLAN

7745 INDIANA AVENUE

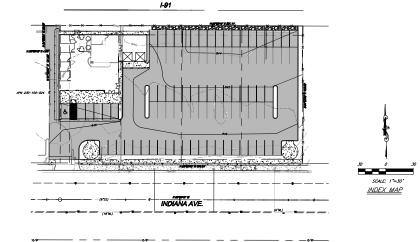

SHEET INDEX

SHEET No. DESCRIPTION

TITLE SHEET PRECISE GRADING PLAN EROSION CONTROL PLAN

LEGAL DESCRIPTION:

OF LOTS 32 THROUGH 35 AS SHOWN ON M.B. 26/29 AND A PORTION OF PARCEL 4 OF R.S. 22/93 ALL OF RECORDS OF RIVERSIDE COUNTY.

NOTE:

EARTH OUALITY SHOWN HERE ARE FOR ESTIMATING PLAN CHECK FEES ONLY. GRADING CONTRACTOR IS RESPONSIBLE TO PERFORM THEIR OWN CALCULATIONS FOR EARTH VOLUME WITH THE SOILS ENGINEER'S RECOMMENDATION. SOILS ENGINEER:

SOIL EXPLORATION COMPANY, INC. 7535 JURUPA AVE. UNIT C RIVERSIDE, CA 92504 (951) 688-7200 PH. (951) 688-7100 FAX

EMERGENCY PHONE NUMBERS

| FIRE DEPARTMENT | (951) | 826-532 |
|-----------------------------------|-------|---------|
| RIVERSIDE POLICE DEPARTMENT | (951) | 826-570 |
| RIVERSIDE UNIFIED SCHOOL DISTRICT | (951) | 788-713 |
| GOODHEW AMBULANCE | (951) | 684-435 |
| AT&T TELEPHONE | (800) | 288-202 |

CITY OF RIVERSIDE PUBLIC
UTILITIES DEPARTMENT _____ (951) 782-0330 SOUTHERN CALIFORNIA UNDERGROUND SERVICE

(800) 227-2600

BASIS OF BEARING:

THE CENTERLINE OF INDIANA AVENUE BEING NORTH 55'59'45" EAST AS SHOWN ON M.B.26/29.

FLOOD ZONE:

FLOOD ZONE = X
COMMUNITY PANEL NO. 06065C-0720G

THOMAS BROTHERS MAP PAGE/GRID:

OWNER/DEVELOPER: WOLF NEJEDLY V LLC 7095 INDIANA AVE #100 RIVERSIDE, CA 92506 (951) 686-7151 PH.

ASSESSORS PARCEL NO.: 230-100-007, 230-100-009, 230-100-016 & 230-100-025

TOTAL ACREAGE: TOTAL ACREAGE (GROSS)

____ 0.93 AC. ____ 0.85 AC. (36,951 S.F.)

CITY OF RIVERSIDE, CALIFORNIA PLANNING DIVISION

ENGINEER: SAKE ENGINEERS INC. 400 S. RAMONA AVE. STE. 202 CORONA, CA 92879 (951) 279-4041 PH. (951) 279-2830 FAX

UTILITIES:

RIVERSIDE SCHOOL DISTRICT TOPOGRAPHY: LANDMARK SURVEYING 14586 CHOKE CHERRY DRIVE VICTORVILLE, CA 92392 ZONING AND LAND USE:

BENCH MARK: F5-K3

P.K. NAIL AND CITY ENGINEER TAG IN THE NOSE OF THE CENTER MEDIAN ISLAND ALONG ADAMS STREET AT INDIANA AVENUE. CITY OF RIVERSIDE BM# F5-K3, NAVD 88 ELEV = 838.853*.

VICINITY MAP SITE

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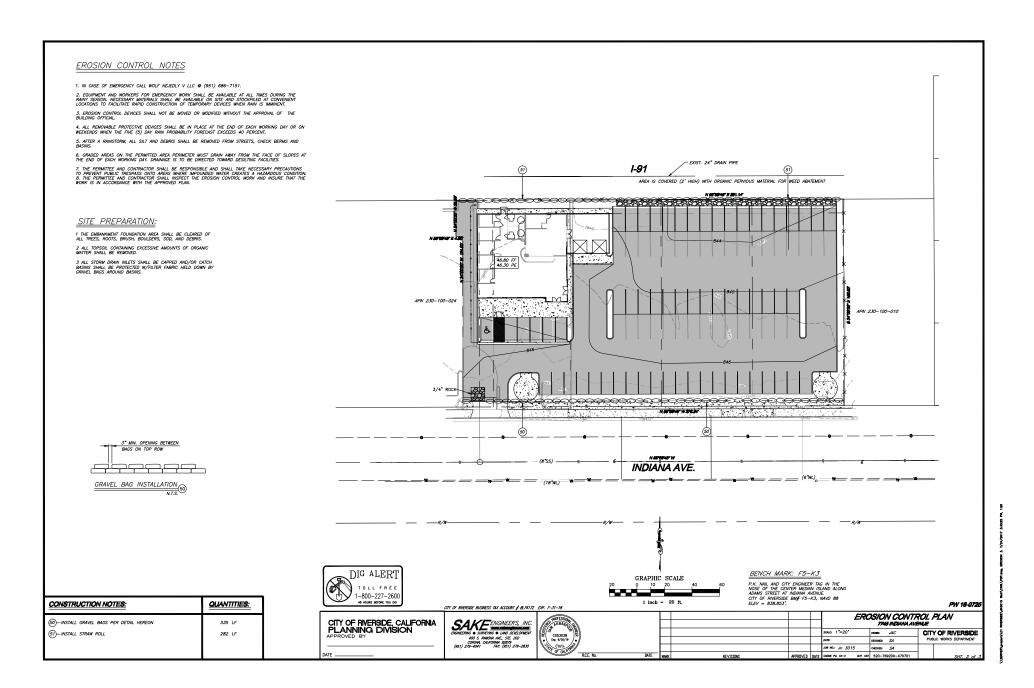
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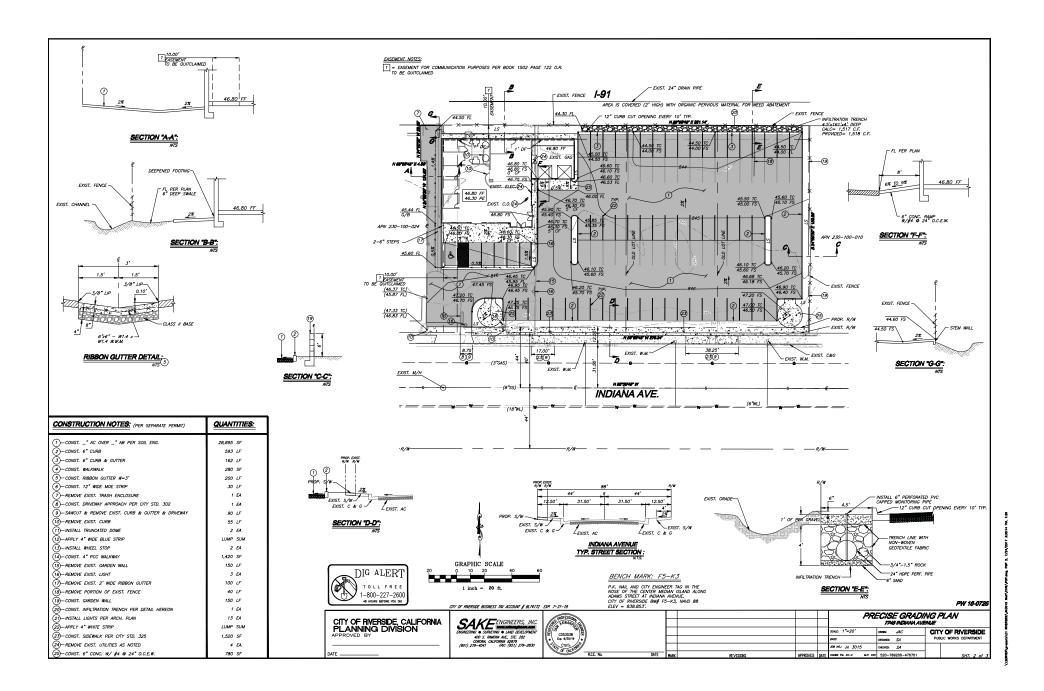
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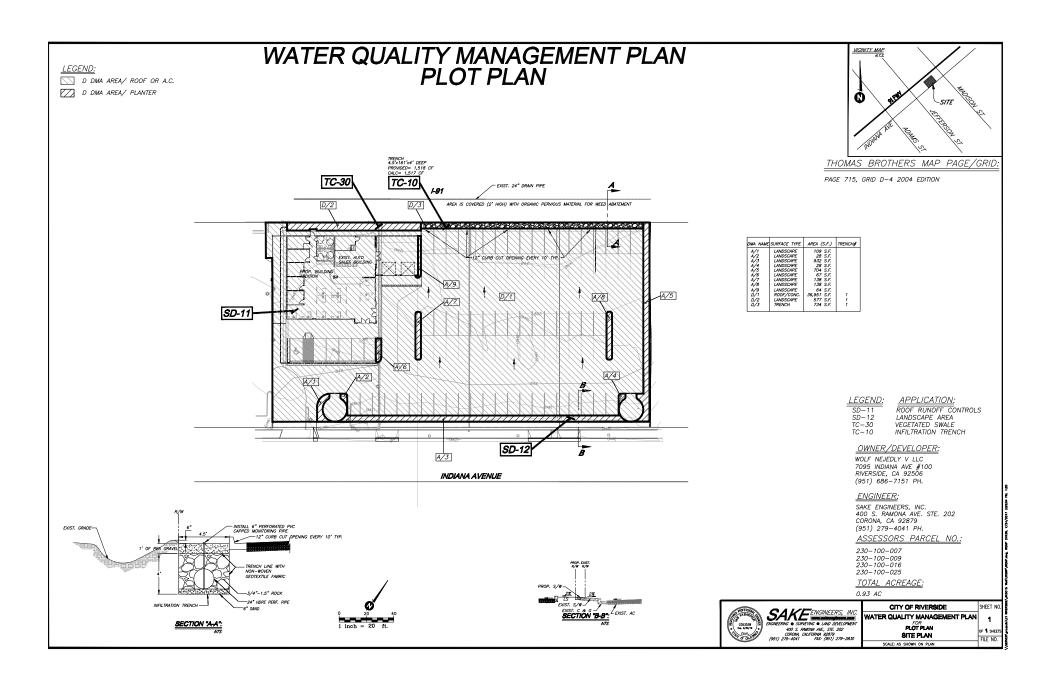
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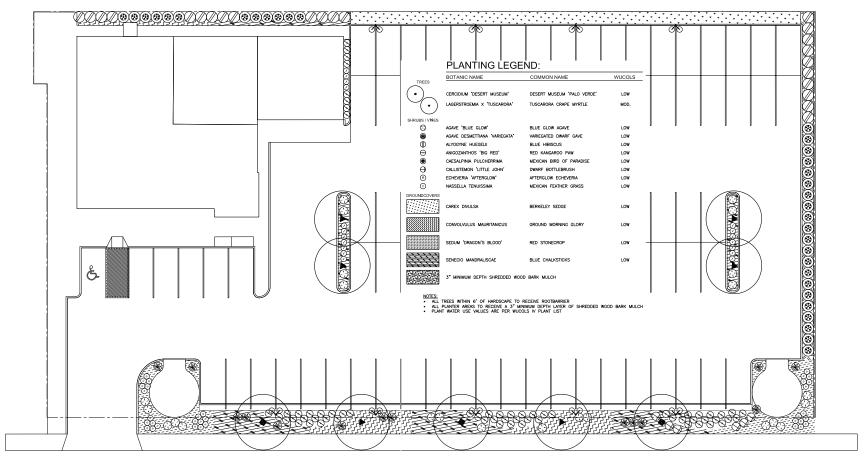
SAKE ENGINEERS, INC.
ENGINEERING • SURVEYING • LAND DEVELOPMENT
400 S. RAMONA ME. 202

100 SERVING • SURVEYING • S C053038 Esp. 6/30/19 CIVIL OF ONE OF









INDIANA AVENUE

PRELIMINARY MASTER PLAN

ENTERPRISE CAR SALE

CITY OF RIVERSIDE








INDIANA AVENUE

PRELIMINARY MASTER PLAN
ENTERPRISE CAR SALE

CITY OF RIVERSIDE

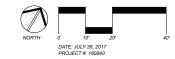



ENTERPRISE CAR SALES

7745 INDIANA AVE. RIVERSIDE, CA 92506

FOR: WOLF NEJEDLY V, LLC 7095 INDIANA AVE, SUITE 100 RIVERSIDE, CA 92506



LANDSCAPE ARCHITECTURE

www.comworksdg.com


4649 Brockton Avenue


Riverside, CA 92506

Phone: (951) 369-0700

Fax: (951) 369-4039

Contact: Kay Kite

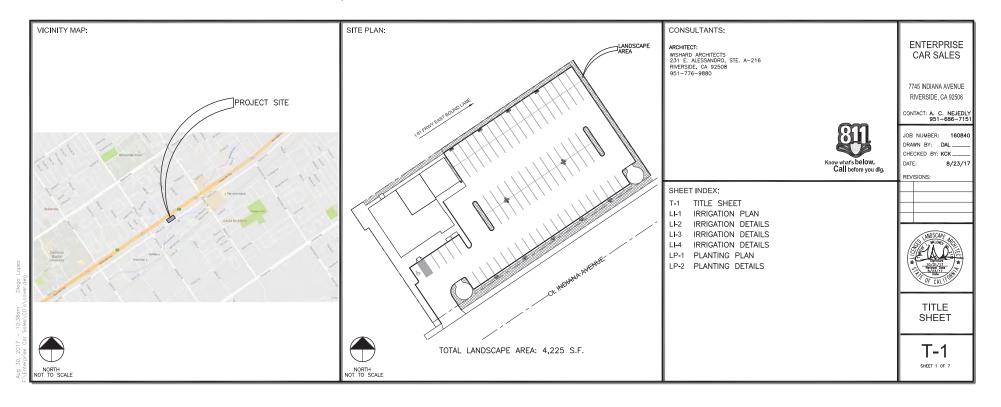

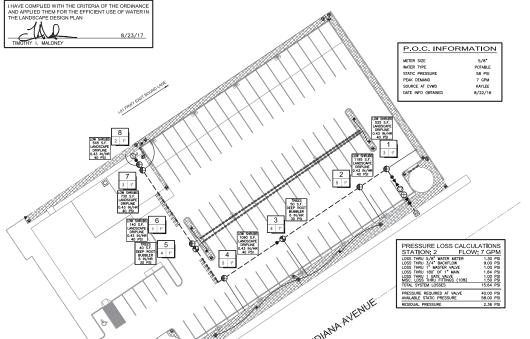

IRRIGATION PLANS ARE DIAGRAMMATIC IN NATURE. IRRIGATION MAINLINE AND ALL VALVE TO BE LOCATED ON PROJECT PROPERTY, IN PLANTER AREAS WHERE POSSIBLE. NO IRRIGATION EQUIPMENT IS TO BE INSTALLED IN STREETS, DRIVE AISLES OR BUILDINGS.

| | EQUIPMENT LEGEND | | | |
|---------------|--|-----------|---------------|------|
| SYMBOL | MANUFACTURER/MODEL # | SIZE | DETAIL | NOTE |
| M | EXISTING WATER METER | 5/8* | N/A | - |
| C | WEATHERMATIC SL1600 SERIES CONTROLLER WITH ONE SLM4 MODULE, SLW1 WIRED WEATHER STATION, AIRCARD AND SLPED PEDESTAL ENCLOSURE | 8 STA. | 'A', LI-2 | (1) |
| M | FEBCO 825Y REDUCED PRESSURE BACKFLOW PREVENTER LOCATED IN A STRONG BOX SBBC-30SS VANDAL RESISTANT ENCLOSURE | 3/4" | 'B', U−2 | (3) |
| 0 | GRISWOLD 2260 NORMALLY OPEN PRESSURE REDUCING MASTER VALVE | 17 | 'C'. ⊔−2 | (2) |
| 0 | WEATHERMATIC SLFSI-T10 FLOW SENSOR | 1" | 'D', LI-2 | (2) |
| M | NIBCO T-585 BRONZE BALL VALVE | 1" | 'E', LI-2 | (2) |
| | RAINBIRD #33DLRC SERIES QUICK COUPLING VALVE | 3/4" | 'F', LI-2 | (2) |
| • | RAINBIRD PEB SERIES ELECTRIC CONTROL VALVE | 1" | 'G', ⊔−2 | (2) |
| • | RAINBIRD XCZ-100-PRB-COM DRIP CONTROL ZONE ASSEMBLY | 17 | 'H', LI-2 | (2) |
| • | RAINBIRD AR-VALVE AIR RELEASE VALVE - LOCATE AT HIGHEST POINT IN DRIP SYSTEM | 1/2" | 'A', LI-3 | (2) |
| • | DRIPLINE FLUSH VALVE - LOCATE PER DRIPLINE DETAILS | UNE SIZE | B, U-3 | (2) |
| | SCH. 40 PVC IRRIGATION MAINLINE - 18" MIN COVER | 1" | 1', U-2 | (2) |
| | CLASS 200 PVC NON-PRESSURE LATERAL LINE - 12" MIN. COVER | 3/4" | 1', LI-2 | (2) |
| | SCH 40 PVC IRRIGATION PIPE / WIRE SLEEVE - 24" MIN. COVER | SEE CHART | 'J', LI−2 | (2) |
| NOT SHOWN | UF RATED CONTROL WIRE, 12 GA COMMON, 14 GA PILOT | 12/14 GA | 'K', U−2 | - |
| ÷ | RAINBIRD OPERIND DRIP OPERATION INDICATOR | - | 'c', u-3 | - |
| | RAINBIRD XFD-06-18 LANDSCAPE DRIPLINE AT 18" O.C. | - | 'D'-'H', LI-3 | - |
| (2) PIPING AM | E CONTRACTOR TO COORDINATE ELECTRICAL POWER W/ ELECTRICAL CONTRACTOR ID VALVES ARE SHOWN IN HARDSCAPE FOR CLARITY ONLY. OR TO LOCATE RACKEL OW PREVENTER IN SHRIJE AREA AND SCREEN WHENEVER PL | SSIRI F. | | |

| BUBBLER LEGEND | | | | | | | | | | | | | | |
|--|-----------------------|--|------|----------|-------|---|---|---|----|------|--------|------|----------|-------|
| SYMBOL | MANUFACTURER/MODEL# | MANUFACTURER/MODEL # NOZZLE RAD. PSI FLOW (GPM) RECH | | DETAIL | NOTES | | | | | | | | | |
| STINDUL | MANUFACTURER/MODEL# | NOZZLE | RAD. | RAD. PSI | Q | T | н | π | TQ | F | Van | RATE | DETAIL | NOTES |
| TREE BUBBLERS | | | | | | | | | | | | | | |
| | RAINBIRD RWS-B-C-1401 | F | | 30 | | | | | | 0.25 | \Box | 3 | 1', LI-2 | (2) |
| + | RAINBIRD RWS-B-C-1402 | F | | 30 | | | | | | 0.50 | П | 6 | 1', U-2 | (1) |
| (1) EACH TREE AND PALM TO RECEIVE TWO BUBBLERS FOR A TOTAL OF 1.0 GPM PER SYMBOL | | | | | | | | | | | | | | |
| (2) EACH TREE TO RECEIVE TWO BUBBLERS FOR A TOTAL OF 0.50 GPM PER SYMBOL | | | | | | | | | | | | | | |

| STATION#/ CONTROLLER | | HYDROZONE AREA IRRIGATION |
|-------------------------|---------------|---------------------------------|
| FLOW (GPM) | VALVE SIZE | TYPE PRECIP RATE PRESSURE |

| SCH 40 PV | C SLEEVI | NG CHART |
|---------------|-------------|----------------|
| 1 1/4" SLEEVE | 1-4 WIRES | 1/2* PIPE |
| 1 1/2" SLEEVE | 5-10 WIRES | 3/4" PIPE |
| 2" SLEEVE | 11-20 WIRES | 1" PIPE |
| 2 1/2" SLEEVE | 21-30 WIRES | 1 1/4" PIPE |
| 3" SLEEVE | 31-40 WIRES | 1 1/2" PIPE |
| 4" SLEEVE | 41-60 WIRES | 2" PIPE |
| 6" SLEEVE | 61-99 WIRES | 2 1/2"-3" PIPE |
| 8" SLEEVE | 100+ WIRES | 4" PIPE |
| 10" SLEEVE | N/A | 6" PIPE |



LANDSCAPE ARCHITECTU

4649 Brockton Ave. Riverside, CA 92506 Phone: (951) 369-0700 Fax: (951) 369-4039 www.comworksdg.com

ENTERPRISE CAR SALES

7745 INDIANA AVENUE RIVERSIDE, CA 92506

| JOB NUMBER: | 160840 |
|-------------|---------|
| DRAWN BY: | DAL |
| CHECKED BY: | KCK |
| DATE: | 8/23/17 |
| DEMICIONIC: | |

(E41510145.



IRRIGATION PLAN

SCALE: 1"=20'-0"



Call before you di

LI-1SHEET 2 OF 7

NORTH 0 20' 40' 80'



SHEET 3 OF 7



LI-3

SHEET 4 OF 7



4649 Brockton Ave. Riverside, CA 92506 Phone: (951) 369-0700 Fax: (951) 369-4039 www.comworksdg.com

ENTERPRISE CAR SALES

7745 INDIANA AVENUE RIVERSIDE, CA 92506

JOB NUMBER: 160840
DRAWN BY: DAL _____
CHECKED BY: KCK ____
DATE: 8/23/17

REVISIONS:



IRRIGATION DETAILS

N.T.S.

SCALE:

Know what's below. Call before you dig.

LI-4

SHEET 5 OF 7

PLANTING LEGEND:

| | BOTANIC NAME | COMMON NAME | SIZE / SPACING | QTY. | WUCOLS | DETAIL |
|----------------|--------------------------------|----------------------------|------------------|------|--------|-----------------|
| TREES | | | | | | |
| (•) | CERCIDIUM 'DESERT MUSEUM' | DESERT MUSEUM 'PALO VERDE' | 24" BOX (MULTI) | 5 | LOW | 'A', SHEET LP-2 |
| (+) | LAGERSTROEMIA X "TUSCARORA" | TUSCARORA CRAPE MYRTLE | 24" BOX (MULTI) | 6 | MOD. | 'A', SHEET LP-2 |
| SHRUBS / VINES | | | | | | |
| • | AGAVE 'BLUE GLOW' | BLUE GLOW AGAVE | 5 GAL. | 24 | LOW | 'C', SHEET LP-2 |
| ₩ | AGAVE DESMETTIANA 'VARIEGATA' | VARIEGATED DWARF GAVE | 5 GAL. | 14 | LOW | 'C', SHEET LP-2 |
| • | ALYOGYNE HUEGELII | BLUE HIBISCUS | 5 GAL. | 23 | LOW | 'C', SHEET LP-2 |
| Θ | ANIGOZANTHOS 'BIG RED' | RED KANGAROO PAW | 1 GAL. | 62 | LOW | 'C', SHEET LP-2 |
| • | CAESALPINIA PULCHERRIMA | MEXICAN BIRD OF PARADISE | 5 GAL. | 33 | LOW | 'C', SHEET LP-2 |
| \oplus | CALLISTEMON 'LITTLE JOHN' | DWARF BOTTLEBRUSH | 5 GAL. | 6 | LOW | 'C', SHEET LP-2 |
| 0 | ECHEVERIA 'AFTERGLOW' | AFTERGLOW ECHEVERIA | 1 GAL. | 34 | LOW | 'C', SHEET LP-2 |
| 0 | NASSELLA TENUISSIMA | MEXICAN FEATHER GRASS | 1 GAL. | 18 | LOW | 'C', SHEET LP-2 |
| GROUNDCOVERS | | | | | | |
| | CAREX DIVULSA | BERKELEY SEDGE | 4" POTS/18" O.C. | 373 | LOW | 'D', SHEET LP-2 |
| | CONVOLVULUS MAURITANICUS | GROUND MORNING GLORY | 1 GAL/36" O.C. | 70 | LOW | 'D', SHEET LP-2 |
| | SEDUM 'DRAGON'S BLOOD' | RED STONECROP | FLATS/12" O.C. | 17 | LOW | 'D', SHEET LP-2 |
| | SENECIO MANDRALISCAE | BLUE CHALKSTICKS | 1 GAL/24" O.C. | 290 | LOW | 'D', SHEET LP-2 |
| | 3" MINIMUM DEPTH SHREDDED WOOD | BARK MULCH | | | | |



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ENTERPRISE CAR SALES

7745 INDIANA AVENUE RIVERSIDE, CA 92506

JOB NUMBER: 160840 DRAWN BY: DAL

PLANTING PLAN

SCALE: 1"=20'-0"



LP-1





N.T.S.

SCALE:



LP-2

SHEET 7 OF 7

1. Will the strict application of the provisions of the Zoning Code result in practical difficulties or unnecessary hardships inconsistent with the general purpose and intent of the Zoning Code?

Yes. Due to the interim nature of the requested block wall, it would be impractical to build a permanent wall for a temporary use. Erecting a block wall would subject the community and its environment to a wasteful burden of erecting, demolishing and discarding of materials into our already overwhelmed landfills. As you know, block walls are not recyclable when disposed of, whereas a privacy slatted chain link fence is almost entirely re-locatable and reusable without impact on the environment and/or landfills.

2. Are there special circumstances or conditions applicable to your property or to the intended use or development of your property that do not apply generally to other property in the vicinity and under the identical zoning classification?

The fence/wall request to identify and "divide" the properties is solely due to timing and the neighboring property owner awaiting their time to sell, rezone and relocate. It is the applicants' intent to acquire the adjacent property and combine it with this project at a future date. The request for a dividing wall is due to the interim zoning difference between the properties and serves no other purpose.

Each of these properties will be ultimately be zoned the same when developed. The parcel that is not participating in the zoning process is to be zoned the same per the general plan. The need for a wall is an interim need and solely due to timing. The need for a dividing wall/fence would not exist if the adjacent property was ready to participate and move on with its consistency zoning.

3. Will the granting of such variance prove materially detrimental to the public welfare or injurious to the property or improvements in the zone or neighborhood in which your property is located?

No. The variance to allow a slatted fence meets the same objective of a masonry wall.

4. Will the granting of such variance be contrary to the objectives of any part of the General Plan?

No. This variance is in keeping with Objective 9 in the Executive Summarization of Riversides 2025 General plan. In Objective 9, "The Built Environment" goals are to **provide for continuing growth** (adding the additional parcel to this development) **while keeping in mind the needs for anticipated growth to achieve the community's objectives**. It is also important to note the goals outlined in all areas of the General Plan to have a low impact on our environment and work to eliminate unnecessary waste. As outlined in the California Green Building Standards Code, the waste that would be generated by an interim block wall would be in conflict with Sections 4.408 and 5.408 as well.



Photo Location Map



1. Site photo number 1 is from Indiana Avenue, looking west at the project site.



2. Photo number 2 is looking northwest at the project site from across Indiana Avenue.



3. Lastly, photo number 3 is from Indiana Avenue, looking northeast at the project site.