



8831 Berdine Avenue, • Ste. #100  
Irving, TX  
969-112  
tel: 940-883-1770  
fax: 940-883-8851  
email: [hpc@txwedge.com](mailto:hpc@txwedge.com)



Developer:  
**Unicenter Construction, Inc.**

4225 Gardner Road  
Livermore, CA 94551  
Tel: 925-441-2610

Research Park | 8


Consultants:  
**RICK ENGINEERING**

卷之三

111

1

**CAUTION : THIS SHEET IS NOT A X-RAY IT IS A MURKED PRINT**

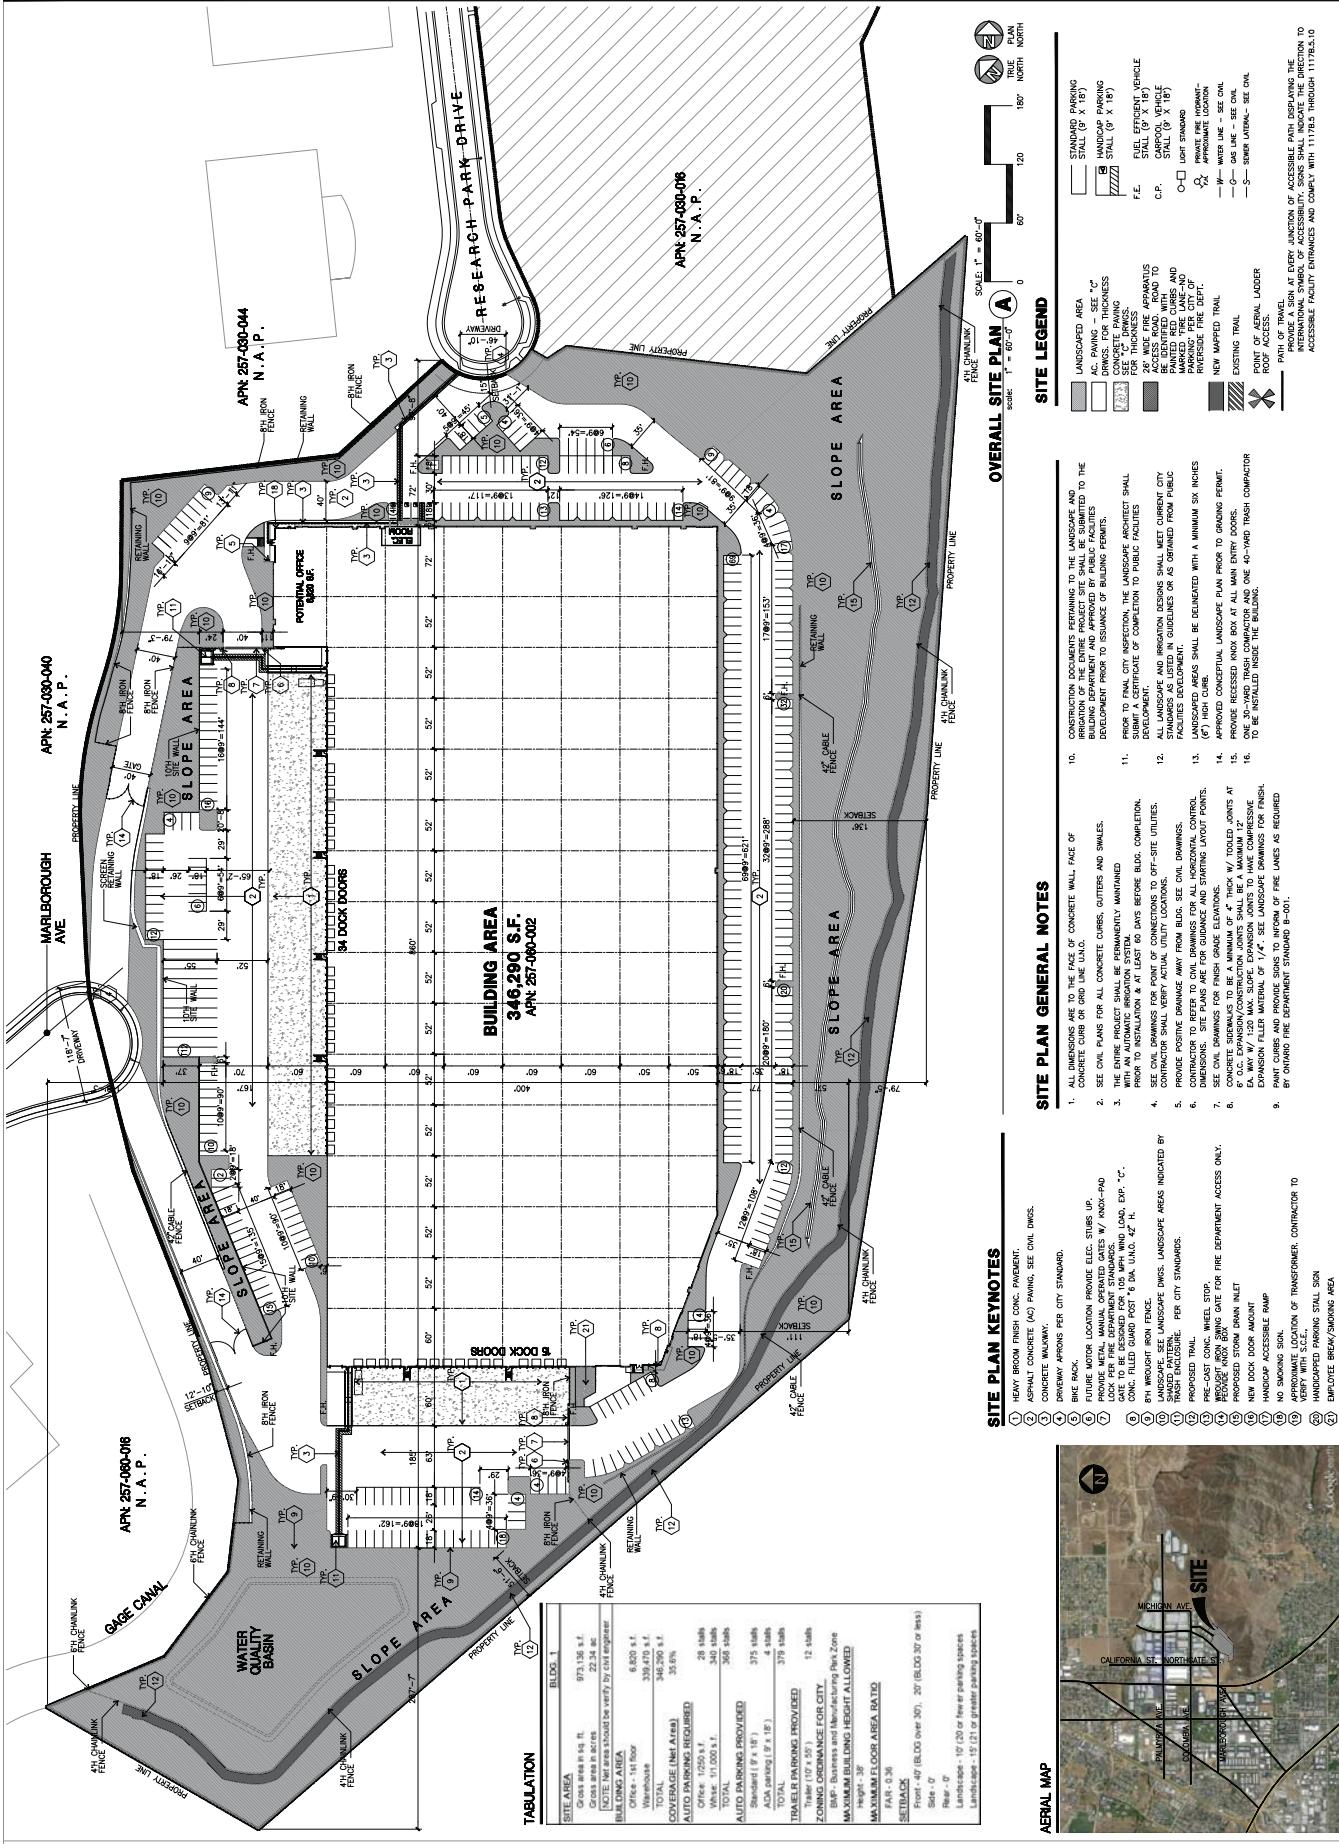

## Exhibit 6 - Project Plans



1001 keedeen avenue - ste. #100  
irvine, ca 92612  
tel: 949-855-1770  
fax: 949-855-0851  
email: hps@harrisca.com



Developer:  
Guthrie Construction, Inc.

4225 Center Road  
Pineville, CA 93220-0010  
Tel: 559-391-0910

easier


## ■ Consultants:

300000000

Verbal  
N.H.  
122917

A1.1 ALT

**SWEET! : IF THIS SWEET IS NOT A SWEET IT IS A BENTONITE TERRIT**

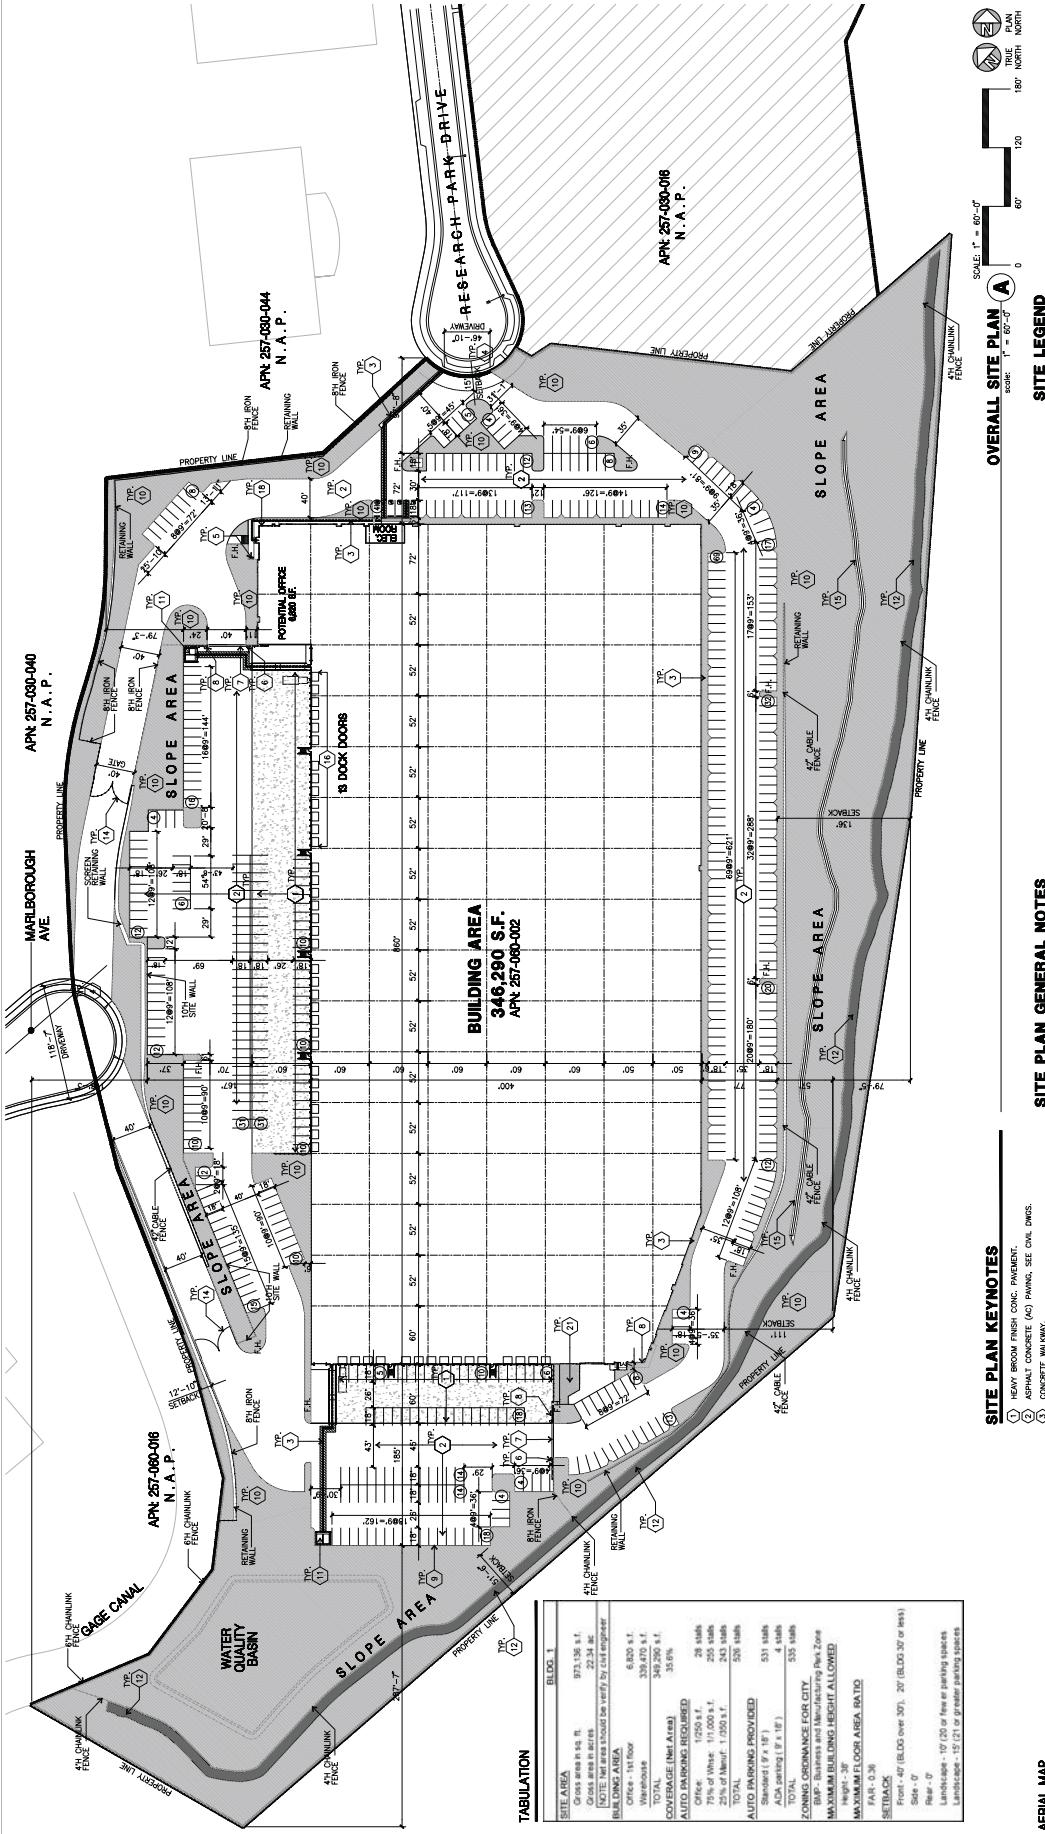

## Exhibit 6 - Project Plans



Inc., Inc.  
16881 Bunker Avenue • Suite #100  
#2012  
Tel: 949-483-1700  
Fax: 949-483-1705  
Email: hpa@hpaarch.com



Developer:  
Jim Cattie Construction, Inc.

2005 Center Point  
Riverside, CA 92506  
Tel: 951-826-1040  
Fax: 951-826-1025

Project:  
Research Park Dr.  
&  
Marlborough Ave  
701 Marlborough  
Riverside, CA 92507

Consultants:  
ROCK ENGINEERING

Chit:

Structural:

Mechanical:

Plumbing:

Electrical:

Landscape:

Steel Engineer:

Fire Protection:

Time:

Overall floor plan

Project Number:

Drawn By:


Date:

Review:

Sheet:

A2.1

CAUTION : IF THIS SHEET IS NOT A 36" X 36" IT IS A REDUCED PRINT

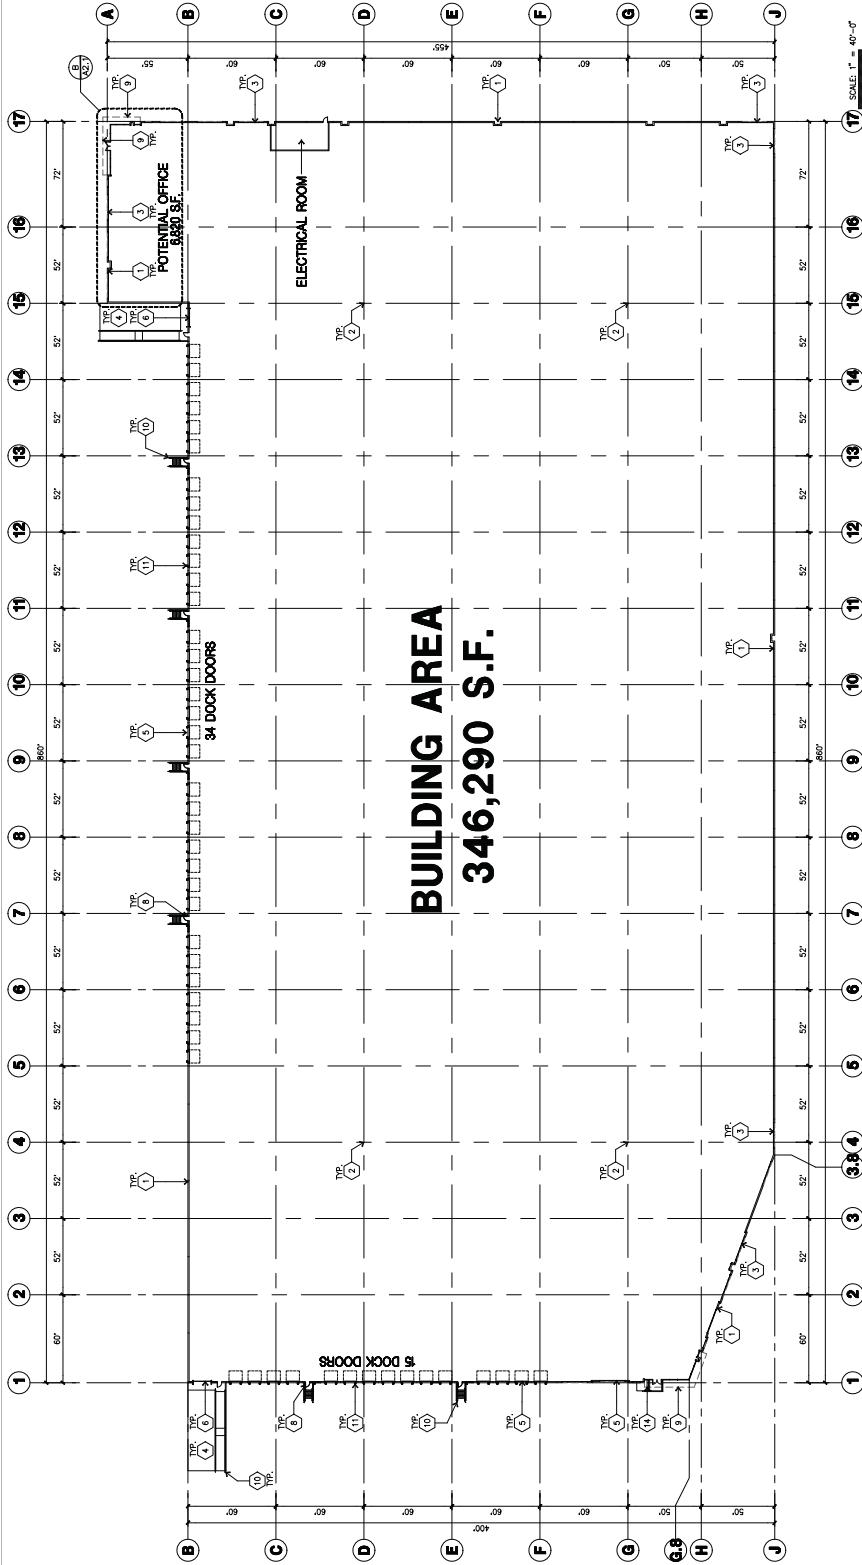

## BUILDING AREA 346,290 S.F.

## KEYNOTES - FLOOR PLAN

## OVERALL FLOOR PLAN

scale: 1" = 40'-0"

0 80

40'

80

40'

80

HPA  
Inc., Inc.  
16881 Bunker Avenue • Suite #100  
Irvine, CA  
92612  
Tel: 949-453-1770  
Fax: 949-453-1751  
Email: hpa@hparch.com



Developer:  
Jim Cuthie Construction, Inc.




Project:  
Research Park Dr  
&  
Marlborough Ave  
707 Marlborough  
Riverside, CA 92507

Consultants:  
ROCK ENGINEERING  
VAL ELECTRIC, INC.  
HUNTER LANDSCAPE  
Field Photocolor:  
Skills Engineer:

Overall Roof Plan  
Time:  
Overall Roof Plan  
Project Number:  
Drawn By:  
Date:  
Revision:


A2.10  
Sheet:

CAUTION: IF THIS SHEET IS NOT A 36" X 36" IT IS A REDUCED PRINT

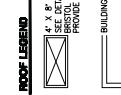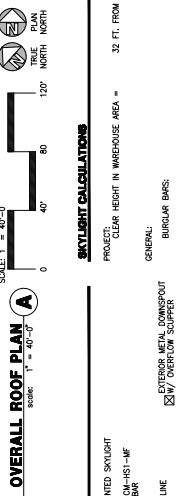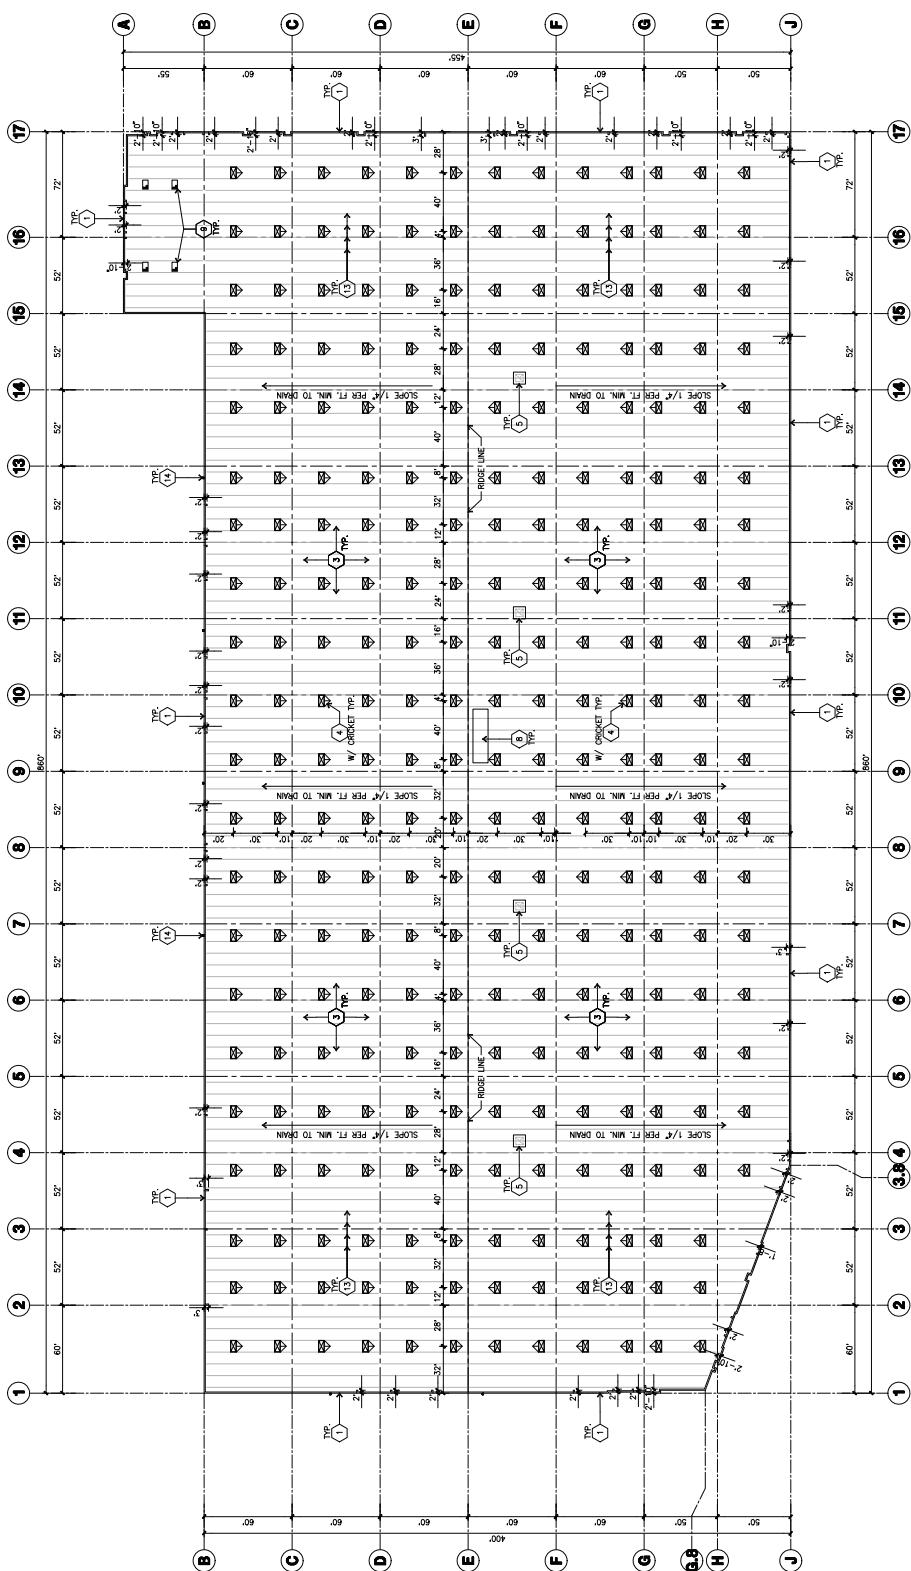

#### ROOF PLAN KEYNOTES

- (1) CONCRETE PARAPET
- (2) NOT USED
- (3) PROVIDE 4'-0" BUILT-UP ROOFING OVER ROOF FRAMING. USE 4'-0" BATTING AND 2'-0" CAP ROOFING. BIG SHELTER MANIFOLD CLASS A RATED. ISOLATE AND SEAL MANIFOLD FROM ROOF DECK. USE 2'-0" MANIFOLD.
- (4) 4' x 8' CURB MOUNTED SKYLIGHT
- (5) EXHAUST FAN
- (6) ROOF HATCH
- (7) INTERIOR ROOF DRAIN WITH OVERFLOW SCUPPERS
- (8) ROOF ADDRESS PAINTED BLACK 4' HIGH W/ 1" WHITE STROKE PER LETTER.
- (9) ROOF HVAC UNIT
- (10) INTERIOR ROOF AND OVERFLOW DRAIN
- (11) NOT USED.
- (12) PARAPET RETURN.
- (13) STRUCTURAL JOIST.
- (14) EXTERIOR ROOF DRAIN WITH 2 OVERFLOW SCUPPERS.

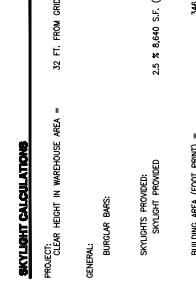

Overall Roof Plan  
Time:  
Overall Roof Plan  
Project Number:  
Drawn By:  
Date:  
Revision: