



NOTE: MANIFOLD STUB MUST BE LAID HORIZONTAL FOR A PROPER FIT IN END CAP OPENING.

MANIFOLD PRECURED INVERTS ARE AVAILABLE UPON REQUEST. MANIFOLD SIZES INCLUDE 48" (1200-1200 mm) SIZE ON SIZE 48" (375-1200 mm) PRECURED INVERTS. CUSTOM MANIFOLD LOCATIONS ON THE MC-350 PRECURED INVERT ARE NOT RECOMMENDED FOR PIPE SIZES LARGER THAN 10" (250 mm). THE LOCATION IN COLUMN "B" IS THE HIGHEST POSSIBLE FOR THE SIZE.

LEGEND

SYMBOL	DESCRIPTION	SYMBOL	DESCRIPTION
	NOTE CALLOUT		DOWNLIGHT FIXTURE - UPPER CASE LETTER INDICATES LIGHT FIXTURE CALLOUT. LOWER CASE LETTER INDICATES LIGHTING CONTROL ZONE.
	DETAIL CALLOUT - NUMBER ON TOP DENOTES DETAIL NUMBER - NUMBER ON BOTTOM DENOTES SHEET DETAIL IS SHOWN		EMERGENCY DOWNLIGHT FIXTURE FED FROM GENERATOR.
	MECHANICAL EQUIPMENT CALLOUT. SEE MECHANICAL PLANS FOR EXACT LOCATION AND REQUIREMENTS		PENDANT LUMINAIRE - UPPER CASE LETTER INDICATES LIGHT FIXTURE CALLOUT. LOWER CASE LETTER INDICATES LIGHTING CONTROL ZONE.
	SECTION CALLOUT		WALLWASH LIGHT FIXTURE - UPPER CASE LETTER INDICATES LIGHT FIXTURE CALLOUT. LOWER CASE LETTER INDICATES LIGHTING CONTROL ZONE.
	FEEDER CALLOUT		WALL MOUNTED LIGHT FIXTURE - UPPER CASE LETTER INDICATES LIGHT FIXTURE CALLOUT. LOWER CASE LETTER INDICATES LIGHTING CONTROL ZONE.
	EXISTING FEEDER CALLOUT		EMERGENCY WALL MOUNTED LIGHT FIXTURE FED FROM GENERATOR.
	NEW LINWORK		BOLLARD LUMINAIRE
	EXISTING LINWORK		POST TOP LUMINAIRE
	DEMOLISHED LINWORK		POLE MOUNTED LUMINAIRE, SINGLE HEAD
	CONDUIT CONCEALED IN WALL OR ABOVE CEILING		POLE MOUNTED LUMINAIRE, DOUBLE HEAD
	CONDUIT EXPOSED		POLE MOUNTED LUMINAIRE, TRIPLE HEAD
	CONDUIT CONCEALED UNDERGROUND OR BELOW FLOOR		POLE MOUNTED LUMINAIRE, QUAD HEAD
	CONDUIT EMERGENCY		IN GRADE LUMINAIRE
	MULTI-CHANNEL RACEWAY		PATHWAY LUMINAIRE
	CONDUIT TURNED UP		LANDSCAPE FIXTURE
	CONDUIT CAPPED		EXIT LIGHT FIXTURE WITH DIRECTIONAL ARROWS AS INDICATED. SHADED SIDE DENOTES NUMBER OF FACES
	BRANCH CIRCUIT HOMERUN TO PANELBOARD AND CIRCUITS AS INDICATED		JUNCTION BOX
	3/4" CONDUIT. TICK MARKS INDICATE QUANTITY OF #12 AWG WIRES (UNLESS NOTED OTHERWISE, NO MARKS INDICATES 2 #12 & 1 #12 GND WIRES). - SMALL MARK DENOTES HOT WIRE - LARGE MARK DENOTES NEUTRAL WIRE - DIAGONAL MARK DENOTES GROUND WIRE		PHOTOCELL FOR EXTERIOR APPLICATIONS
	GENERATOR		DAYLIGHT SENSOR - CEILING MOUNTED
	SWITCH		RELAY
	CIRCUIT BREAKER		EMERGENCY RELAY UL 924 COMPLIANT
	2-WAY SWITCH, TRANSFER SWITCH		MOTION SENSOR - CEILING MOUNTED
	FUSE		MOTION SENSOR - CORNER OR WALL MOUNTED
	TRANSFORMER		MOTION SENSOR WITH AISLE/CORRIDOR LENS - CEILING MOUNTED
	GROUND CONNECTION		COMBINATION MOTION AND DAYLIGHT SENSOR
	MOTOR - SINGLE PHASE FRACTIONAL OR INTEGRAL HORSEPOWER		LIGHTING CONTROL NETWORK DEVICE
	METER		DIGITAL TIMER SWITCH
	ELECTRONIC CIRCUIT MONITOR		MOTION SENSOR SWITCH
	480V DRAWOUT BREAKER		LOW VOLTAGE SWITCH
	VARIABLE FREQUENCY DRIVE		DIMMER MASTER SWITCH
	PANEL		DIGITAL DIMMING SWITCH
	FUSED DISCONNECT SWITCH		GRAPHICAL TOUCH SCREEN - LIGHTING CONTROL STATION
	NON-FUSED DISCONNECT SWITCH		THERMOSTAT WITH A 3/4" CONDUIT TO ACCESSIBLE CEILING SPACE
	COMBINATION STARTER/DISCONNECT SWITCH		MODULAR FURNITURE - BASE POWER WHIP FEED CONNECTION
	SWITCH MOTOR RATED		MODULAR FURNITURE - FLOOR BOX FEED CONNECTION
	SPLICE		MODULAR FURNITURE - POWER POLE FEED CONNECTION
	TERMINATION		20A, 125V MODULAR FURNITURE RECEPTACLE (TO BE PROVIDED AS PART OF THE FURNITURE)
	EXISTING TERMINATION		20A, 125V MODULAR FURNITURE RECEPTACLE (HALF) CONTROLLED RECEPTACLE (TO BE PROVIDED AS PART OF THE FURNITURE)
	MEDIUM VOLTAGE - AIR CIRCUIT BREAKER DRAWOUT BREAKER		LIGHTING CONTROL PANEL - SURFACE MOUNTED
	MEDIUM VOLTAGE FUSED DISCONNECT SWITCH		PANELBOARD - RECESSED MOUNTED
	MEDIUM VOLTAGE MODULAR SPLICE		PANELBOARD - SURFACE MOUNTED
	MEDIUM VOLTAGE EXISTING MODULAR SPLICE		DISTRIBUTION PANEL/ BOARD
	2X4 LIGHT FIXTURE - UPPER CASE LETTER INDICATES LIGHT FIXTURE CALLOUT. LOWER CASE LETTER INDICATES LIGHTING CONTROL ZONE.		SINGLE POLE SWITCH, DEVICE SHALL BE MOUNTED + 48" MAX AND + 36" MIN FROM THE CENTER OF DEVICE:
	2X4 EMERGENCY LIGHT FIXTURE FED FROM GENERATOR.		SWITCH 3-WAY (48" AFF MAXIMUM)
	2X2 LIGHT FIXTURE - UPPER CASE LETTER INDICATES LIGHT FIXTURE CALLOUT. LOWER CASE LETTER INDICATES LIGHTING CONTROL ZONE.		TIMER SWITCH (48" AFF MAXIMUM)
	2X2 EMERGENCY LIGHT FIXTURE FED FROM GENERATOR.		DUAL SWITCH (48" AFF MAXIMUM)
	LINEAR LIGHT FIXTURE, DIMENSIONS PER PLANS - UPPER CASE LETTER INDICATES LIGHT FIXTURE CALLOUT. LOWER CASE LETTER INDICATES LIGHTING CONTROL ZONE.		PUSHBUTTON SWITCH
	EMERGENCY LINEAR LIGHT FIXTURE, DIMENSIONS PER PLANS - LIGHT FIXTURE FED FROM GENERATOR.		RECESSED ON WALL SURFACE G=GFI, WP=WEATHERPROOF C=CEILING
	LINEAR PENDANT LIGHT FIXTURE, DIMENSIONS PER PLANS - UPPER CASE LETTER INDICATES LIGHT FIXTURE CALLOUT. LOWER CASE LETTER INDICATES LIGHTING CONTROL ZONE.		20A, 125V DUPLEX RECEPTACLE MOUNTED + 15' AFF. UNLESS OTHERWISE NOTED
	TRACK LIGHTING - UPPER CASE LETTER INDICATES LIGHT FIXTURE CALLOUT. LOWER CASE LETTER INDICATES LIGHTING CONTROL ZONE.		20A, 125V QUAD RECEPTACLE MOUNTED + 15' AFF. UNLESS OTHERWISE NOTED
	UNDERCABINET / COVE FIXTURE - UPPER CASE LETTER INDICATES LIGHT FIXTURE CALLOUT. LOWER CASE LETTER INDICATES LIGHTING CONTROL ZONE.		20A, 125V DUPLEX RECEPTACLE RECEPTACLE ON DEDICATED CIRCUIT
	LED STRIP LIGHT FIXTURE - UPPER CASE LETTER INDICATES LIGHT FIXTURE CALLOUT. LOWER CASE LETTER INDICATES LIGHTING CONTROL ZONE.		20A, 125V CONTROLLED DUPLEX RECEPTACLE

ABBREVIATIONS

ABBREVIATION	DESCRIPTION	ABBREVIATION	DESCRIPTION
&	AND	LFMC	LIQUIDTIGHT FLEXIBLE METAL CONDUIT
1/C	SINGLE CONDUCTOR	LGST	LARGEST
@	AT	LIS	LOAD INTERRUPTER SWITCH
A OR AMP	AMPERES	LOC	LOCATION
A.C.	ASPHALT CONCRETE	LOTO	LOCK-OUT & TAG-OUT
ABV	ABOVE	LSI	LONG TERM, SHORT TERM, INSTANTANEOUS
AF	AMPERE FUSE RATING	LSIG	LONG TERM, SHORT TERM, INSTANTANEOUS GROUNDING
AFc	AVAILABLE FAULT CURRENT	LTG	LIGHTING
AFF	ABOVE FINISHED FLOOR	LV	LOW VOLTAGE
AFG	ABOVE FINISHED GRADE	M	METER
AIC	AMPERE INTERRUPTING CAPACITY	MAX	MAXIMUM
AL	ALUMINUM	MCA	MINIMUM CIRCUIT AMPS
APPROX.	APPROXIMATE	MCC	MOTOR CONTROL CENTER
ARCH.	ARCHITECT, ARCHITECTURAL	MCP	MOTOR CIRCUIT PROTECTOR
AS	AMPERE SWITCH RATING	MFR, MFR	MANUFACTURER
ASCC	AVAILABLE SHORT CIRCUIT CURRENT	MH	MANHOLE
ATC	AIR TERMINAL CHAMBER	MI	MECHANICAL INTERLOCK
ATO	AUTOMATIC THROW-OVER (SWITCH)	MIN	MINIMUM
ATS	AUTOMATIC TRANSFER SWITCH	MOCP	MAXIMUM OVERCURRENT PROTECTION
AUTO	AUTOMATIC	MRCT	MULTI-RATIO CURRENT TRANSFORMER
AUX	AUXILIARY	MTD	MOUNTED
AWG	AMERICAN WIRE GAUGE	MTG	MOUNTING
B.S.	BARE STRANDED	MTR	MOTOR
BAT	BATTERY	MTTB	MAIN TELEPHONE TERMINAL BOARD
BEL	BELOW	MV	MEDIUM VOLTAGE
BKBD	BACKBOARD	N	NORTH
BKR	BREAKER	NAC	NOTIFICATION APPLIANCE CIRCUIT
BLDG	BUILDING	NC	NORMALLY CLOSED
C	CONDUIT	NEC	NATIONAL ELECTRICAL CODE
C.O.	CONDUIT ONLY WITH PULL WIRE	NF	NON-FUSED
CB	CIRCUIT BREAKER	NIC	NOT IN CONTRACT
CC	CONSTANT CURRENT	NL	NIGHT LIGHT- 24HRS ON
CKT	CIRCUIT	NO	NUMBER
CL	CENTER LINE	OC	ON CENTER
CLG	CEILING	OCPD	OVERCURRENT PROTECTIVE DEVICE
CMU	CONCRETE MASONRY UNIT	OE	OVERHEAD ELECTRICAL
COL	COLUMN	OFC	OIL FUSED CUTOFF
CP	COMMUNICATION PROCESSOR	OH	OVER HEAD
CPT	CONTROL POWER TRANSFORMER	OL	OIL LEVER SWITCH
CR	CONTROL RELAY	P	POLE
CSFD	COMBINATION SMOKE FIRE DAMPER	PAC	PROGRAMMABLE AUTOMATION
CT	CURRENT TRANSFORMER	PB	PULL BOX
CU	COPPER	PC	PHOTOCELL
CW	COLD WATER	PCB	POLYCHLORINATED BIPHENYL
DIAG	DIAGRAM	PDS	PRESSURE DIFFERENTIAL SWITCH
DIS	DISCONNECT	PF	POWER FACTOR
DIST.	DISTANCE	PH OR Ø	PHASE
DL	DAMP LOCATION LISTING	PIC	PAPER INSULATED, LEAD COVER
DM	DIGITAL METER	PIV	POST INDICATING VALVE
DMM	DIGITAL METER MODULE	PL	PLATE
DP	DISTRIBUTION PANEL	PLC	PROGRAMMABLE LOGIC CONTROLLER
DWG	DRAWING	PNL	PANEL
DWP	DEPARTMENT OF WATER & POWER	POC	POINT OF CONNECTION
EA	EACH	PREF.	PREFERRED
ECM	ELECTRIC CIRCUIT MONITOR	PRI	PRIMARY
ELEC.	ELECTRICAL	PVC	POLY-VINYL CHLORIDE
EM	EMERGENCY	PWR	POWER
EMH	ELECTRICAL MANHOLE	REC/RECEPT	RECEPTACLE
EMT	ELECTRICAL METALLIC TUBING	REQD	REQUIRED
EPO	EMERGENCY POWER OFF	RGS	RIGID GALVANIZED STEEL
EPR	ETHYLENE PROPYLENE RUBBER	RM	ROOM
EQUIP	EQUIPMENT	RMC	RIGID METAL CONDUIT
ERR	EXISTING TO BE RELOCATED AND RECONNECTED	RBP	REDUCED PRESSURE BACK FLOW PREVENTER
EXIST(E)	EXISTING	RTAC	REAL TIME AUTOMATION CONTROLLER
EXP	EXPLOSION PROOF	SCCR	SHORT CIRCUIT CURRENT RATING
FA	FIRE ALARM	SCE	SOUTHERN CALIFORNIA EDISON
FACP	FIRE ALARM CONTROL PANEL	SF	SQUARE FEET
FATC	FIRE ALARM TERMINAL CABINET	SHT	SHEET
FFE	FINISHED FLOOR ELEVATION	SIG.	SIGNAL
FIN.	FINISH	SP	SPARE
FIP.	FIELD INTERFACE PANEL	SPECS	SPECIFICATIONS
FIXT	FIXTURE	ST	STREET
FLA	FULL LOAD AMPS	STD	STANDARD
FLR	FLOOR	STP	SHIELDED TWISTED PAIR
FLUOR	FLUORESCENT	SW	SWITCH
FMC	FLEXIBLE METAL CONDUIT	SWBD	SWITCHBOARD
FO	FIBER OPTIC	SWGR	SWITCHGEAR
FT	FEET	SWST	SWITCHING STATION
FTG	FOOTING	T.O.D.	TOP OF DUCTBANK
GEN	GENERATOR	T.O.M.	TOP OF MANHOLE
GFI	GROUND FAULT INTERRUPTER	TB	TERMINAL BLOCK
GFR	GROUND FAULT RELAY	TEL./TELE	TELEPHONE
GG	GREEN GROUND	TMH	TELEPHONE MANHOLE
GND	GROUND	TPS	TWISTED SHIELDED PAIR
HOA	HAND-OFF-AUTOMATIC	TRANSF, XFMR	TRANSFORMER
HP	HORSEPOWER	TS	TAMPER SWITCH
HT	HEIGHT	TYP	TYPICAL
HTR	HEATER	UG	UNDERGROUND
HW	HIGH VOLTAGE	UON	UNLESS OTHERWISE NOTED
HZ	HERTZ	V	VOLTS
ICON	INTEGRATED COMMUNICATIONS OPTICAL NETWORK	VA	VOLT-AMPERES
IE	INVERT ELEVATION	VB	VIBRATION SWITCH
IED	INTELLIGENT ELECTRONIC DEVICE	VFD	VARIABLE FREQUENCY DRIVE
IMC	INTERMEDIATE METAL CONDUIT	W	WATTS
INCAND	INCANDESCENT	W/	WITH
ISC	SHORT CIRCUIT CURRENT	W/O	WITHOUT
J.B, J-BOX	JUNCTION BOX	WP	WEATHERPROOF
KOMIL	THOUSAND CIRCULAR MILS	Z	IMPEDANCE
KV	KILOVOLT		
KVA	KILOVOLT-AMPERES		
KW	KILOWATT		
LF	LINEAR FEET		
IN THE EVENT ABBREVIATIONS NOT MENTIONED HEREIN ARE USED, REFERENCE WILL BE MADE TO ANSI Y1.1, MILITARY STANDARD ABBREVIATIONS AND OTHER STANDARD INDUSTRY CONVENTIONS			

GENERAL NOTES

- ALL WORK SHALL COMPLY WITH THE 2022 EDITION OF THE CALIFORNIA ELECTRICAL CODE AND ALL OTHER APPLICABLE FEDERAL AND STATE. WHERE THE CONSTRUCTION DOCUMENTS INDICATE MORE RESTRICTIVE REQUIREMENTS, THE CONSTRUCTION DOCUMENTS SHALL GOVERN BUT THE CONSTRUCTION DOCUMENTS SHALL NOT BE INTERPRETED AS AUTHORITY TO VIOLATE ANY CODE OR REGULATION.
- ALL MATERIALS AND EQUIPMENT SHALL BE NEW AND SHALL BEAR THE UNDERWRITERS LABEL (UL) AND SHALL BE INSTALLED IN THE MANNER FOR WHICH THEY ARE DESIGNED AND APPROVED.
- THE CONTRACTOR SHALL NOT BORE, NOTCH OR IN ANY WAY CUT INTO ANY STRUCTURAL MEMBER WITHOUT WRITTEN APPROVAL FROM THE ARCHITECT OR STRUCTURAL ENGINEER.
- MECHANICAL, ELECTRICAL AND PLUMBING EQUIPMENT ANCHORAGE NOTES:
 - ALL MECHANICAL, PLUMBING, AND ELECTRICAL COMPONENTS SHALL BE ANCHORED AND INSTALLED PER THE DETAILS ON THE APPROVED CONSTRUCTION DOCUMENTS. WHERE NO DETAIL IS INDICATED, THE FOLLOWING COMPONENTS SHALL BE ANCHORED OR BRACED TO MEET THE FORCES AND DISPLACEMENT REQUIREMENTS.
 - A. ALL PERMANENT EQUIPMENT AND COMPONENTS.
 - B. TEMPORARY OR MOVABLE EQUIPMENT THAT IS PERMANENTLY ATTACHED (E.G. HARD WIRED) TO THE BUILDING UTILITY SERVICES SUCH AS ELECTRICITY, GAS OR WATER.
 - C. MOVABLE EQUIPMENT WHICH IS STATIONED IN ONE PLACE FOR MORE THAN 8 HOURS AND HEAVIER THAN 400 POUNDS ARE REQUIRED TO BE ANCHORED WITH TEMPORARY ATTACHMENTS.
 - THE ATTACHMENT OF THE FOLLOWING MECHANICAL AND ELECTRICAL COMPONENT SHALL BE POSITIVELY ATTACHED TO THE STRUCTURE, BUT NEED NOT BE DETAILED ON THE PLANS. THESE COMPONENTS SHALL HAVE FLEXIBLE CONNECTIONS PROVIDED BETWEEN THE COMPONENT AND ASSOCIATED DUCTWORK, PIPING, AND CONDUIT.
 - A. COMPONENTS WEIGHING LESS THAN 20 POUNDS AND HAVE A CENTER OF MASS LOCATED 4 FEET OR LESS ABOVE THE ADJACENT FLOOR OR ROOF LEVEL THAT DIRECTLY SUPPORTS THE COMPONENT.
 - B. COMPONENTS WEIGHING LESS THAN 20 POUNDS, OR IN THE CASE OF DISTRIBUTED SYSTEMS, LESS THAN 5 POUNDS PER FOOT, WHICH ARE SUSPENDED FROM A ROOF OR FLOOR OR HUNG FROM A WALL.
 - FOR THOSE ELEMENTS THAT DO NOT REQUIRE DETAILS ON THE APPROVED DRAWINGS, THE INSTALLATION SHALL BE SUBJECT TO THE APPROVAL OF THE STRUCTURAL ENGINEER OF RECORD AND THE STRUCTURAL ENGINEER. THE PROJECT INSPECTOR WILL VERIFY THAT ALL COMPONENTS AND EQUIPMENT HAVE BEEN ANCHORED IN ACCORDANCE WITH ABOVE REQUIREMENTS.
- PIPING, DUCTWORK, AND ELECTRICAL DISTRIBUTION SYSTEM BRACING NOTES:
 - PIPING, DUCTWORK, AND ELECTRICAL DISTRIBUTION SYSTEMS SHALL BE BRACED TO COMPLY WITH THE FORCES AND DISPLACEMENTS PRESCRIBED IN LATEST SECTIONS OF CBC AND ASCE.
 - THE BRACING AND ATTACHMENTS TO THE STRUCTURE SHALL BE DETAILED ON THE APPROVED DRAWINGS OR THEY SHALL COMPLY WITH ONE OF THE OSHPD PRE-APPROVALS (OPM #) AS MODIFIED TO SATISFY ANCHORAGE REQUIREMENTS OF ACI 318, APPENDIX D.
 - COPIES OF THE MANUAL SHALL BE AVAILABLE ON THE JOBSITE PRIOR TO THE START OF HANGING AND BRACING OF THE PIPE, DUCTWORK, AND ELECTRICAL DISTRIBUTION SYSTEMS.
 - THE STRUCTURAL ENGINEER OF RECORD SHALL VERIFY THE ADEQUACY OF THE STRUCTURE TO SUPPORT THE HANGER AND BRACE LOADS.

SHEET INDEX

SHEET	DESCRIPTION
E0.01	GENERAL NOTES, LEGEND, ABBREVIATIONS AND SHEET INDEX
E1.01	ELECTRICAL SITE PLAN - RENOVATION
E2.01	FIRST FLOOR POWER PLAN
E4.01	ENLARGED PLANS
E5.01	SINGLE LINE DIAGRAM
E6.01	DETAILS
ED1.01	ELECTRICAL SITE PLAN - DEMOLITION



Boulder Associates

300 SPECTRUM CENTER DR, SUITE 730
IRVINE, CALIFORNIA 92618
949.727.9000

PROJECT P246459.00

PACIFIC GROVE
ACUTE
PSYCHIATRIC
FACILITY

5900 BROCKTON AVE., RIVERSIDE,
CA 92506

DEVELOPMENT
APPLICATION / CUP

DATE 03/28/2025

REVISIONS

Δ	DESCRIPTION	DATE
---	-------------	------

HCAI
H241744-33-00


APPROVAL STAMP

SHEET TITLE
**GENERAL NOTES,
LEGEND,
ABBREVIATIONS AND
SHEET INDEX**


SHEET NUMBER

E0.01

3/28/2025 2:05:08 PM
Autodesk Docs://246459.MW Pacific Grove Acute Psych H25124-0555_MWPT_A25_CENTRAL.rvt
THIS SHEET IS UNCLASIFIED WHEN PRINTED TO FULL SCALE
©BOULDER ASSOCIATES

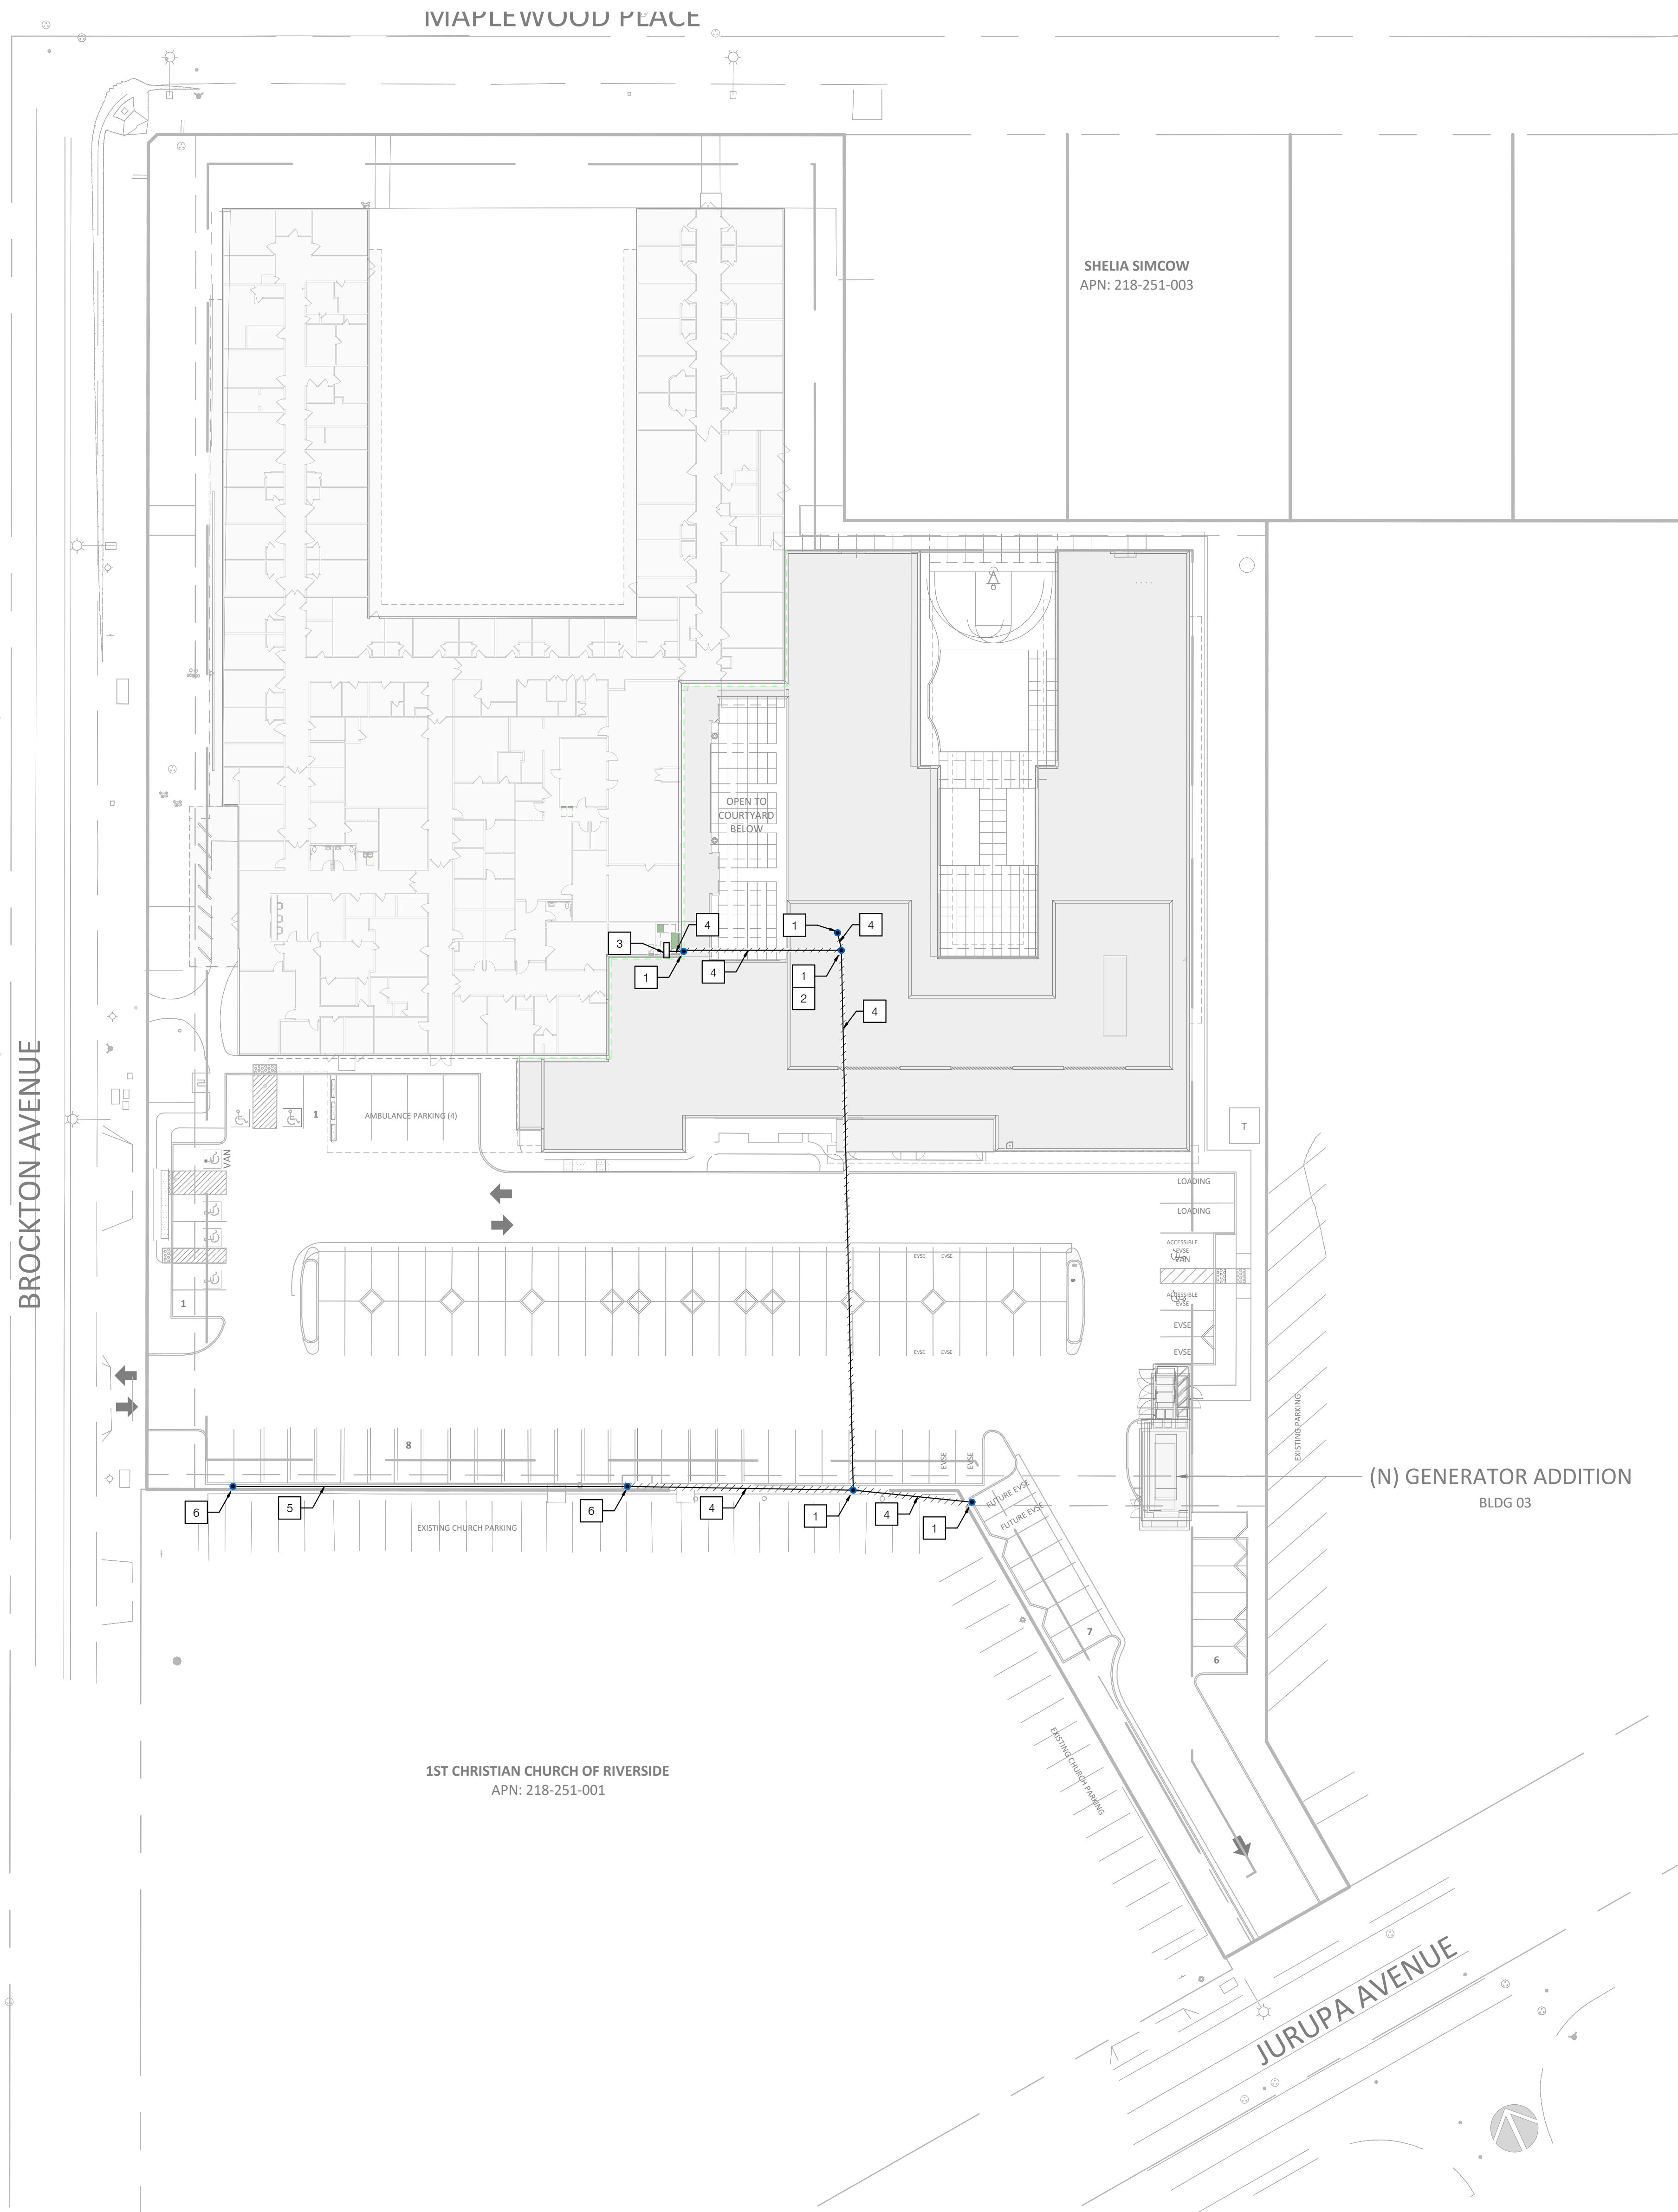

1 ELECTRICAL SITE PLAN - DEMOLITION
SCALE: 1" = 30'-0"

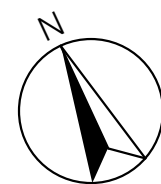

- NOTES**
- 1 RIVERSIDE PUBLIC UTILITIES TO DEMOLISH EXISTING POWER POLE.
 - 2 RIVERSIDE PUBLIC UTILITIES TO DEMOLISH EXISTING POLE MOUNTED UTILITY TRANSFORMER FEEDING THE EXISTING BUILDING MAIN SERVICE SWITCHBOARD.
 - 3 EXISTING MAIN SERVICE SWITCHBOARD SERVING EXISTING BUILDING. METER #336366679
 - 4 EXISTING OVERHEAD UTILITY CABLES TO BE DEMOLISHED BY RIVERSIDE PUBLIC UTILITIES.
 - 5 EXISTING OVERHEAD UTILITY CABLES TO REMAIN.
 - 6 EXISTING UTILITY POLE TO REMAIN.

BA
BOULDER ASSOCIATES
300 SPECTRUM CENTER DR, SUITE 730
IRVINE, CALIFORNIA 92618
949.727.9000

PROJECT P246459.00

**PACIFIC GROVE
ACUTE
PSYCHIATRIC
FACILITY**

5900 BROCKTON AVE., RIVERSIDE,
CA 92506

**DEVELOPMENT
APPLICATION / CUP**


DATE 03/28/2025

REVISIONS	DESCRIPTION	DATE
1		

HCAI
H241744-33-00
APPROVAL STAMP

SHEET TITLE
**ELECTRICAL SITE PLAN -
DEMOLITION**

SHEET NUMBER
ED1.01

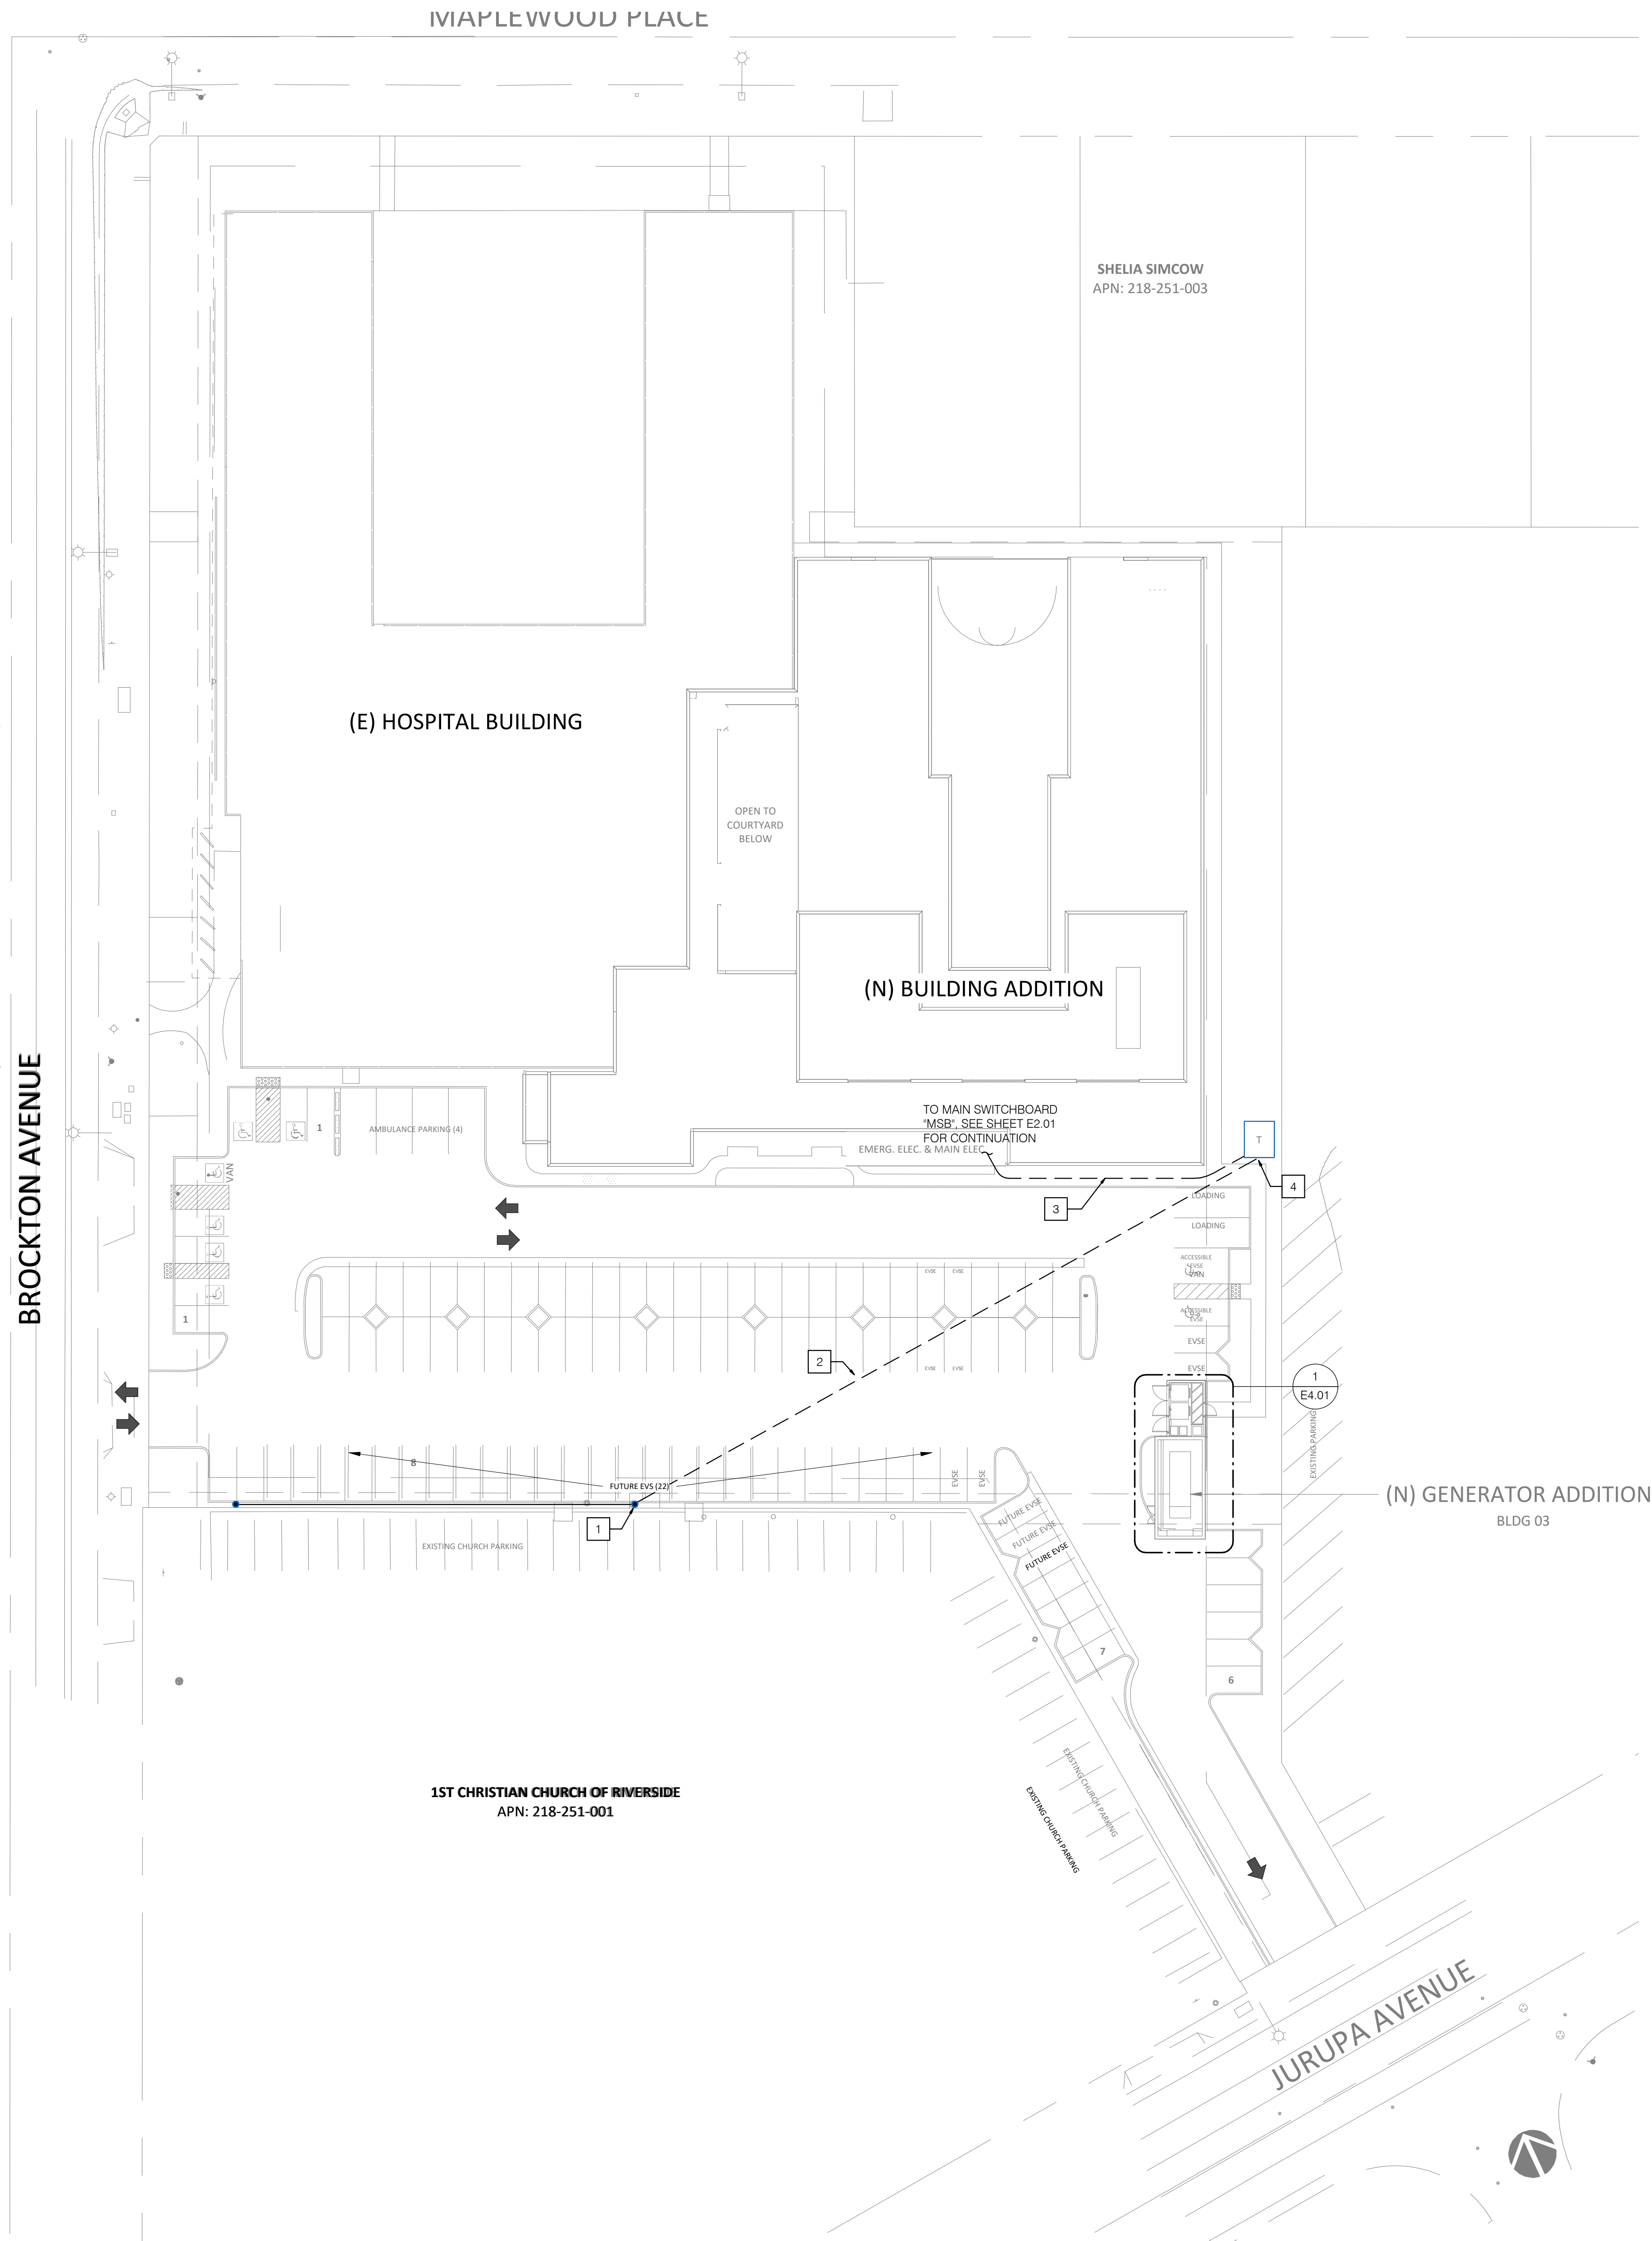

- NOTES**
- EXISTING UTILITY POLE TO FEED THE NEW UTILITY PAD MOUNT TRANSFORMER.
 - PROVIDE UNDERGROUND CONDUITS TO FEED NEW UTILITY TRANSFORMER FROM EXISTING POWER POLE. MEDIUM VOLTAGE CABLES PROVIDED BY UTILITY.
 - PROVIDE UNDERGROUND CONDUITS ONLY TO NEW 2000A MAIN SERVICE SWITCHBOARD. 208Y/120V CABLES PROVIDED BY UTILITY.
 - PROVIDE CONCRETE PAD FOR PAD MOUNT TRANSFORMER MEETING RIVERSIDE PUBLIC UTILITY REQUIREMENTS. PAD MOUNT TRANSFORMER PROVIDED BY RIVERSIDE PUBLIC UTILITIES.

BA
BOULDER ASSOCIATES
300 SPECTRUM CENTER DR., SUITE 730
IRVINE, CALIFORNIA 92618
949.727.9000

PROJECT P246459.00

**PACIFIC GROVE
ACUTE
PSYCHIATRIC
FACILITY**

5900 BROCKTON AVE., RIVERSIDE,
CA 92506

**DEVELOPMENT
APPLICATION / CUP**

DATE 03/28/2025

REVISIONS	DESCRIPTION	DATE
1		

HCAI
H241744-33-00
APPROVAL STAMP

SHEET TITLE
**ELECTRICAL SITE PLAN -
RENOVATION**

SHEET NUMBER
E1.01

