# SCHOLARSHIP PREP **RIVERSIDE**

9707 MAGNOLIA AVENUE RIVERSIDE, CA 92503 **RED HOOK CAPITAL PARTNERS** 

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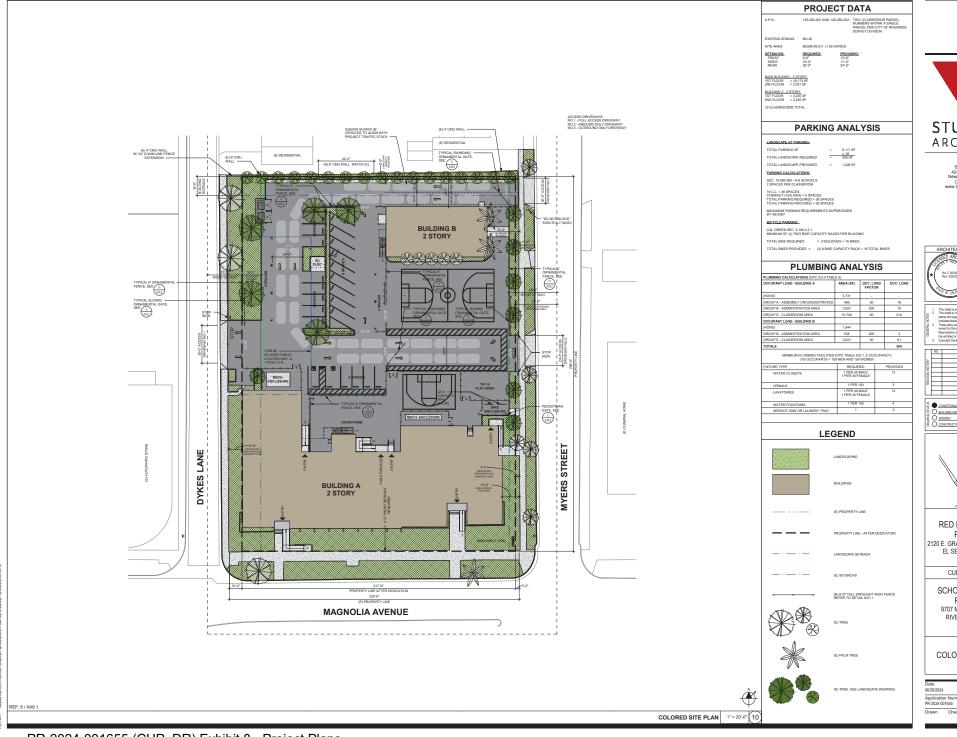


RED HOOK CAPITAL **PARTNERS** 2120 E. GRAND AVENUE, SUITE 135 EL SEGUNDO, CA 90245

CUP RESUBMITTAL

SCHOLARSHIP PREP RIVERSIDE 9707 MAGNOLIA AVENUE RIVERSIDE, CA 92503

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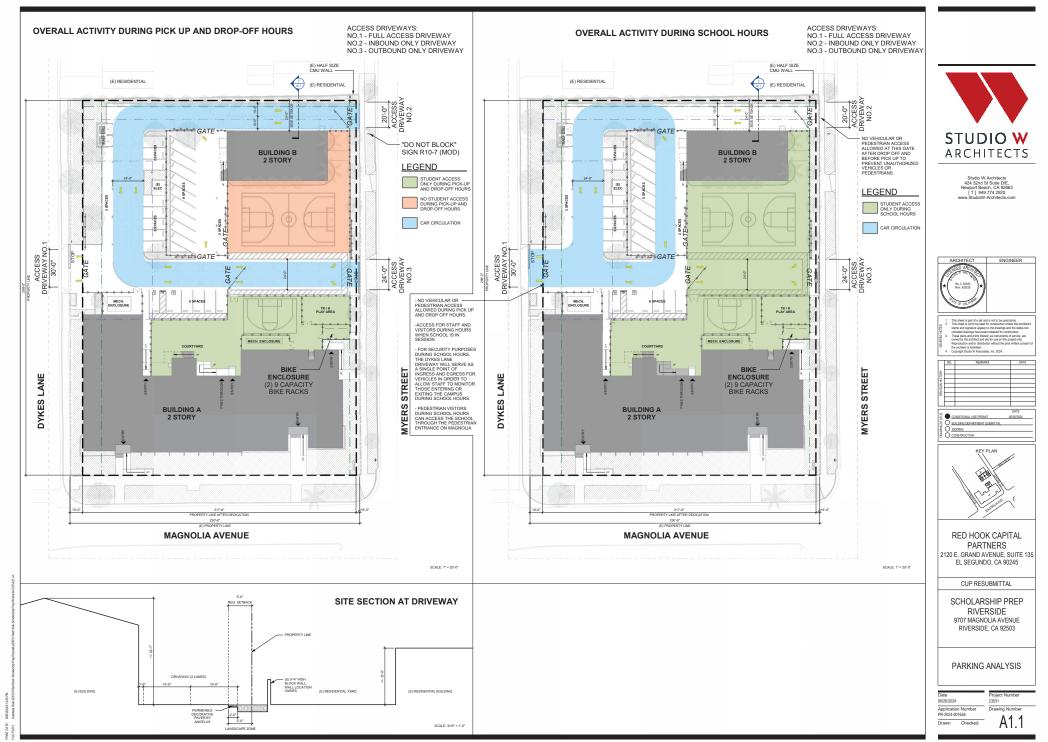
RED HOOK CAPITAL **PARTNERS** 2120 E. GRAND AVENUE, SUITE 135 EL SEGUNDO, CA 90245


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COLORED SITE PLAN

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#### RED HOOK CAPITAL PARTNERS


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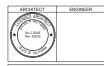
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> PRELIMINARY LANDSCAPE PLAN

Application Number PR-2024-001655 Drawn Checked



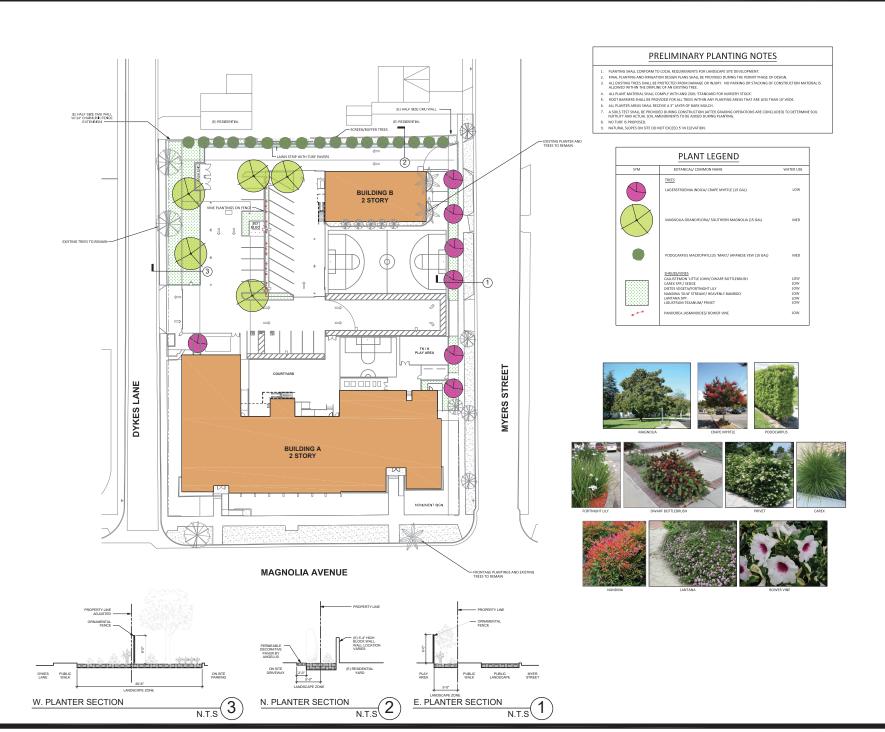

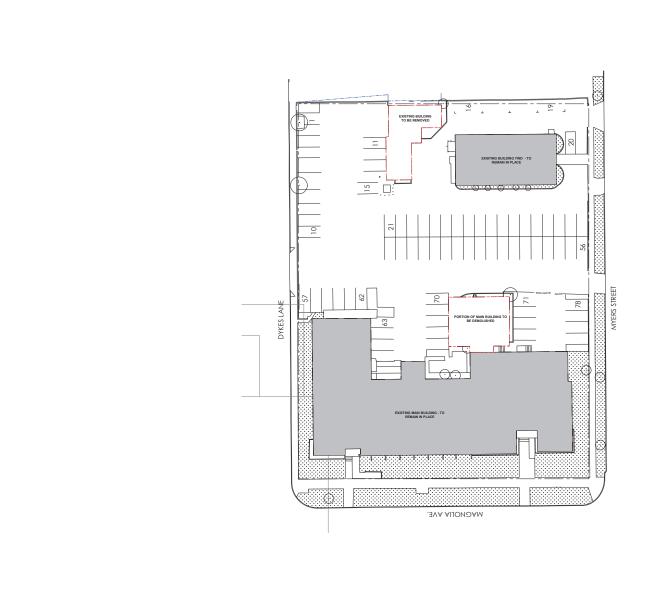

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RED HOOK CAPITAL PARTNERS
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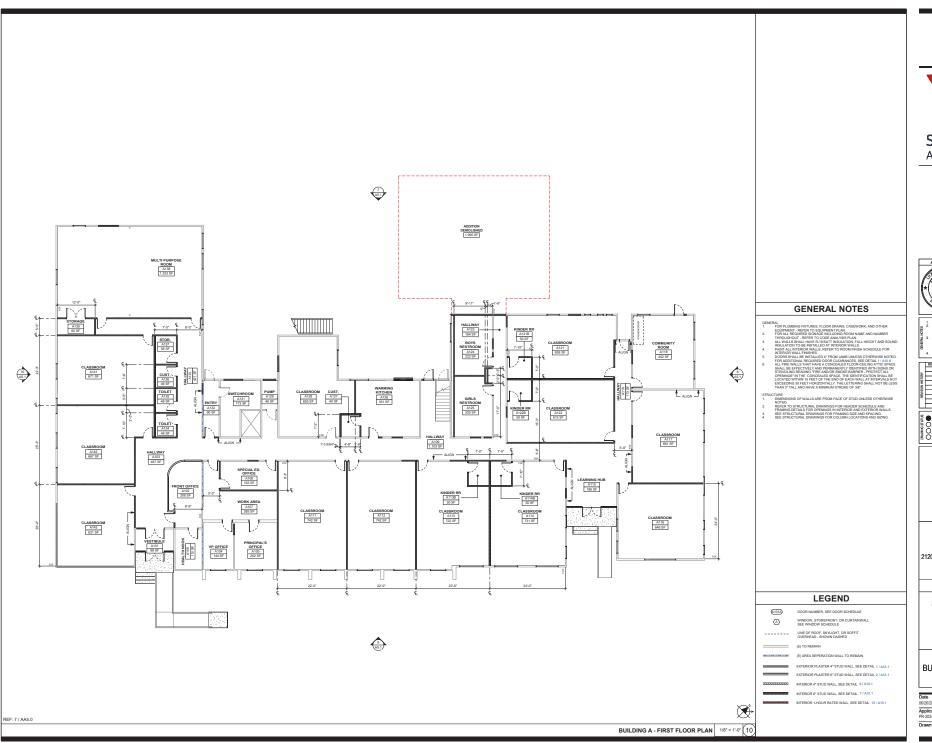
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SCHOLARSHIP PREP RIVERSIDE 9707 MAGNOLIA AVENUE RIVERSIDE, CA 92503

DEMO SITE PLAN

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1" = 20'-0" DEMO SITE PLAN








RED HOOK CAPITAL **PARTNERS** 2120 E. GRAND AVENUE, SUITE 135 EL SEGUNDO, CA 90245

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SCHOLARSHIP PREP RIVERSIDE 9707 MAGNOLIA AVENUE RIVERSIDE, CA 92503

BUILDING A (MAIN BUILDING) - FIRST FLOOR PLAN



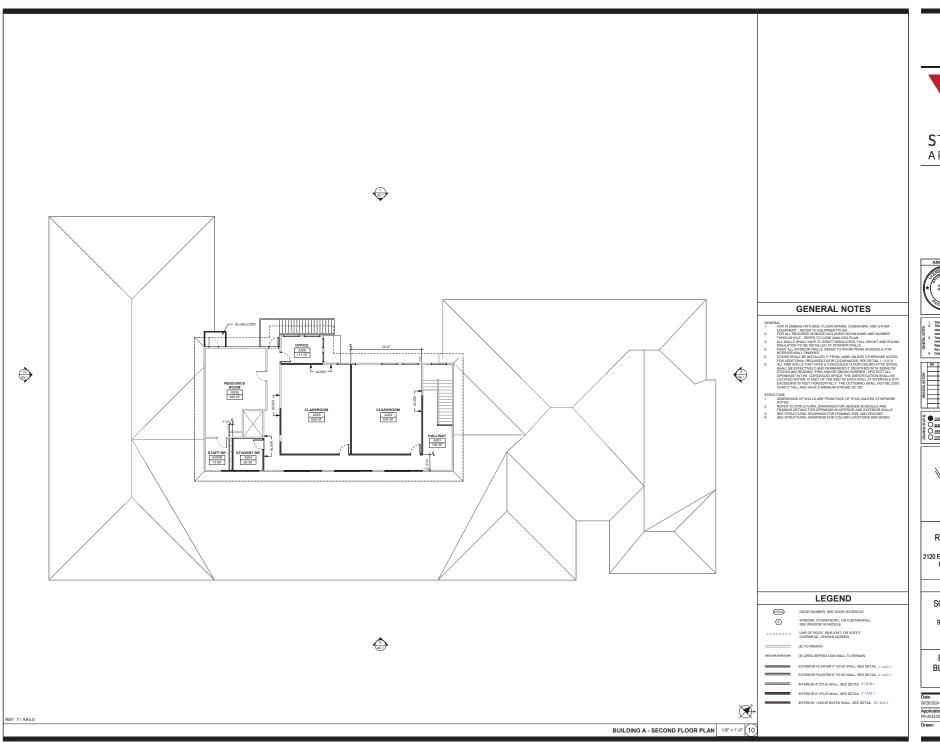

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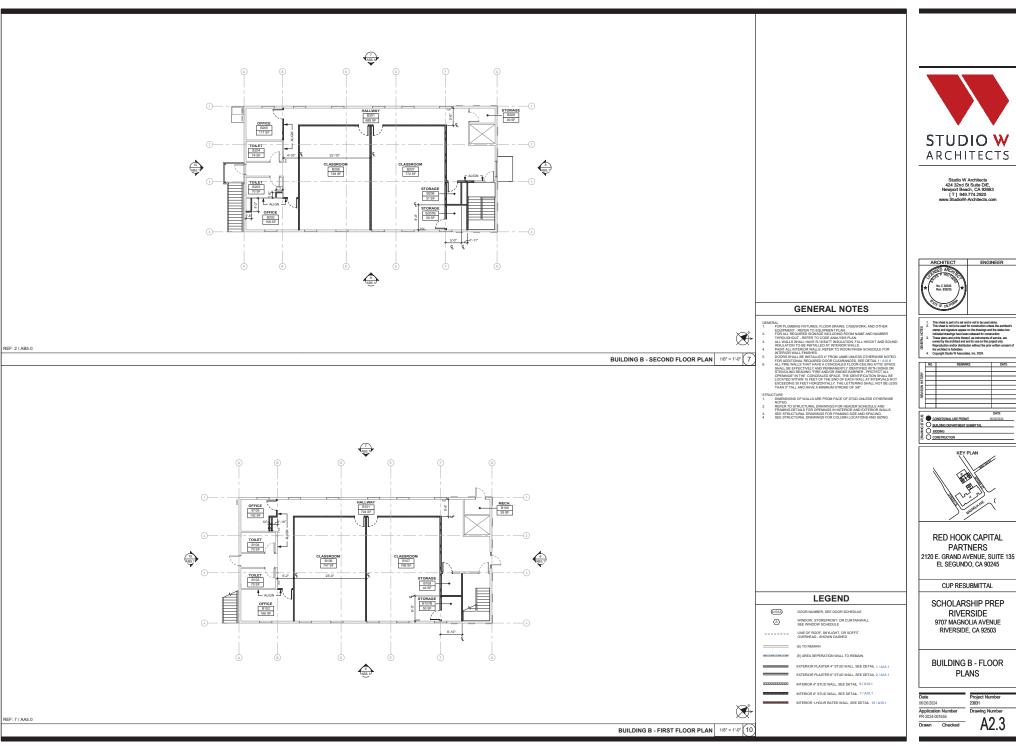
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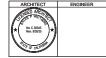
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BUILDING A (MAIN BUILDING) - SECOND FLOOR PLAN

Date Pr 06/26/2024 23 Application Number PR-2024-001655








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BUILDING B - FLOOR PLANS







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**GENERAL NOTES** 
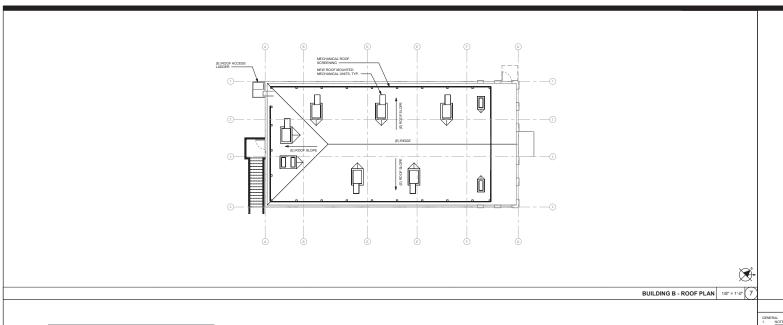
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#### RED HOOK CAPITAL PARTNERS

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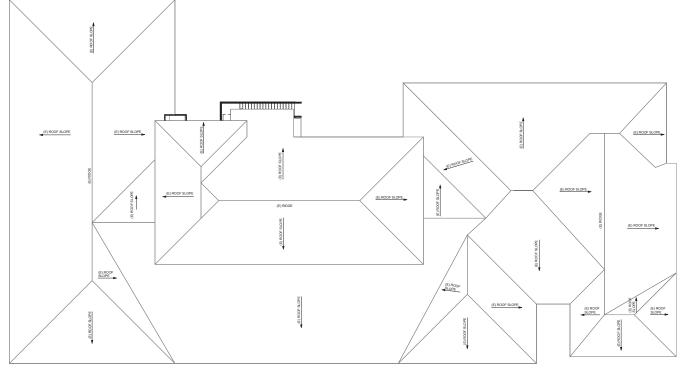
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#### SCHOLARSHIP PREP RIVERSIDE

9707 MAGNOLIA AVENUE RIVERSIDE, CA 92503

**ROOF PLANS** 

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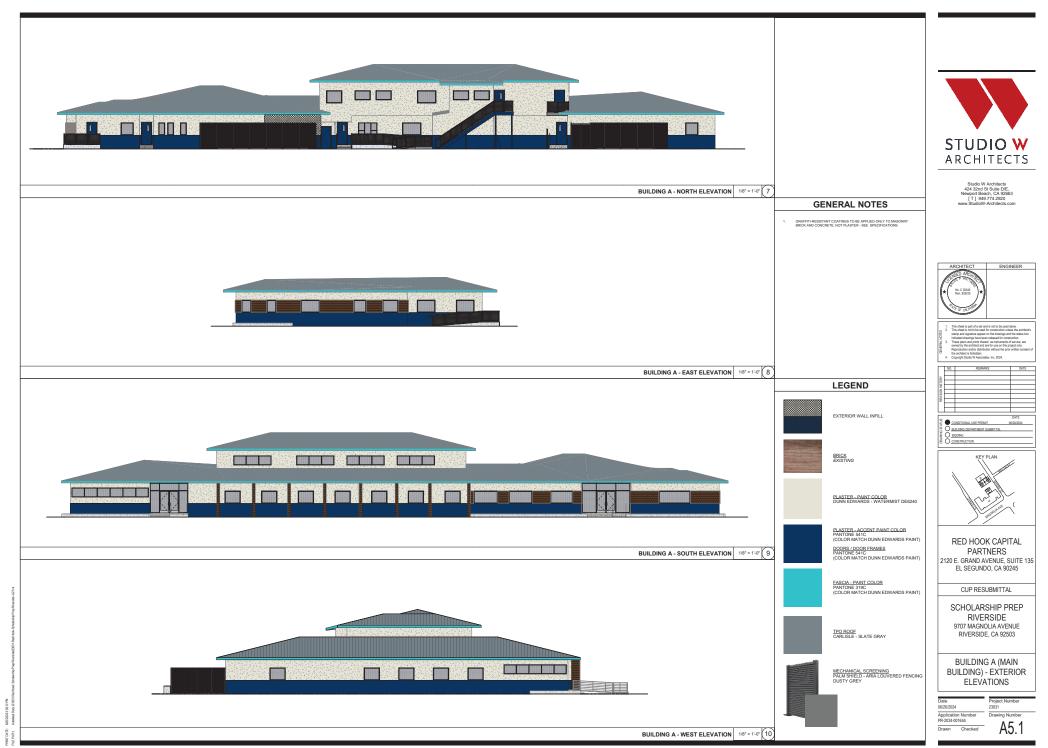
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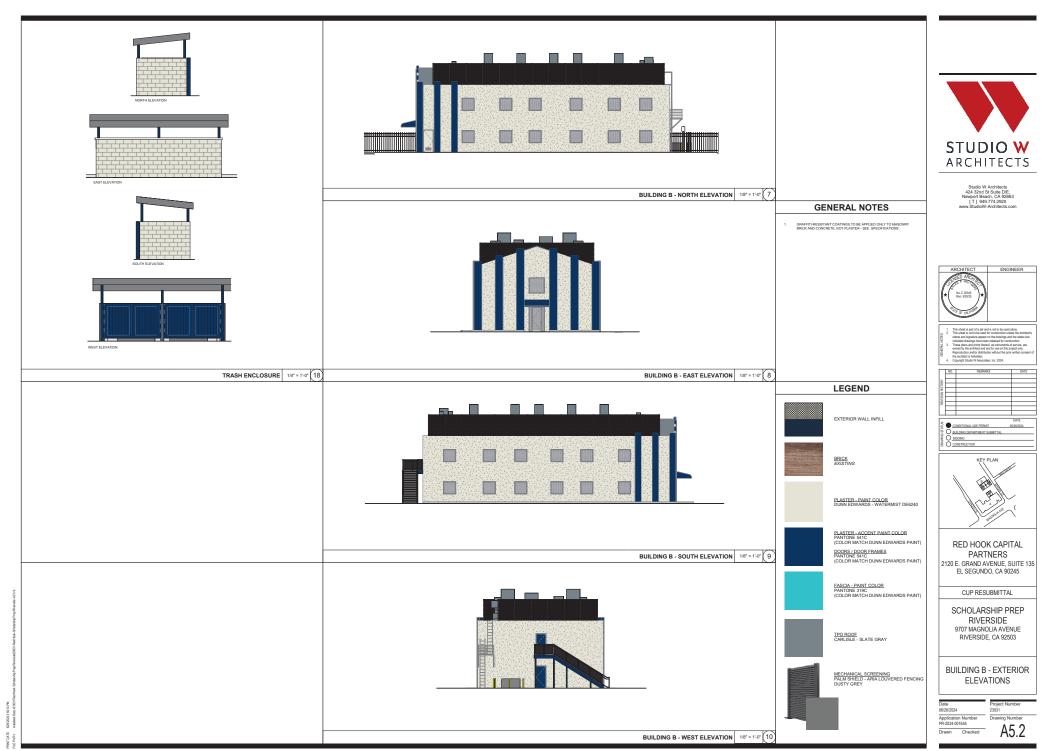
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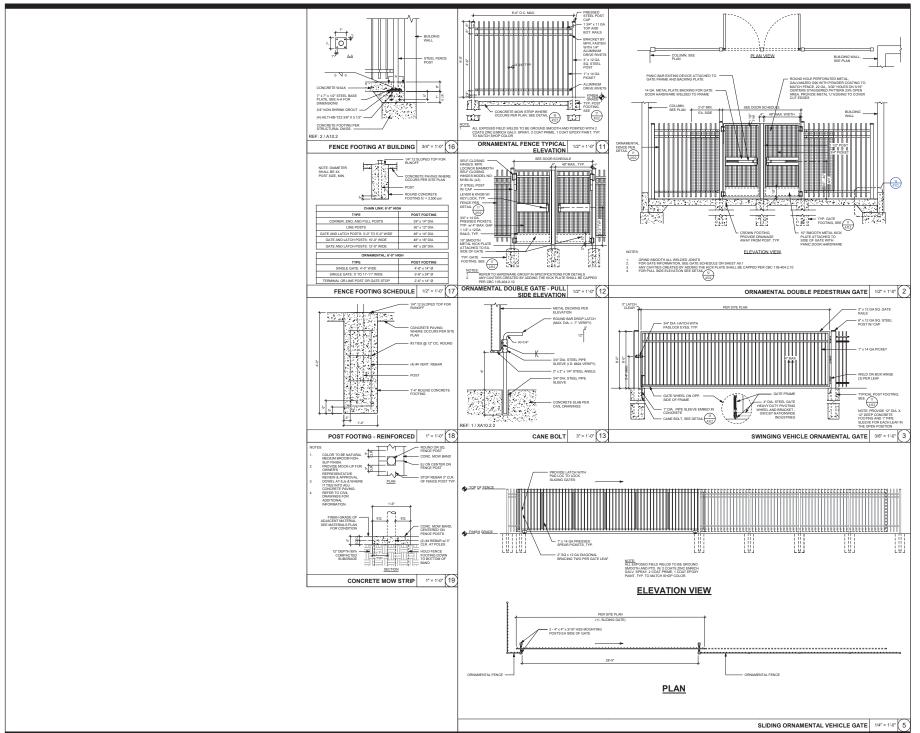
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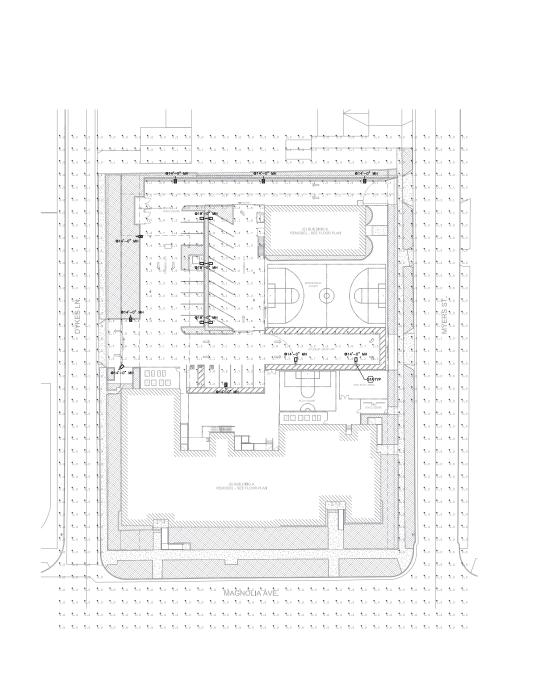
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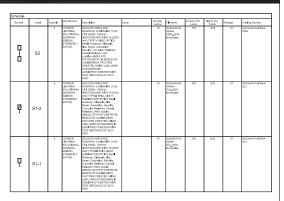
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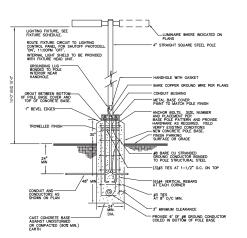
SITE DETAILS

06/26/2024 Application Number PR-2024-001655 Drawn Checked Author Checker















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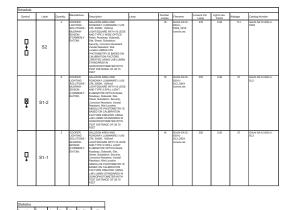
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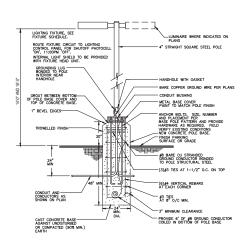
LIGHTING SITE PHOTOMETRICS PLAN

06/26/2024 Application Number PR-2024-001655 PR-2024-001655
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LIGHTING SITE PHOTOMETRICS PLAN 1" = 20'-0" 1











Studio W Architects 424 32nd St Suite D/E, Newport Beach, CA 92663 [T] 949.774.2920



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ACTION

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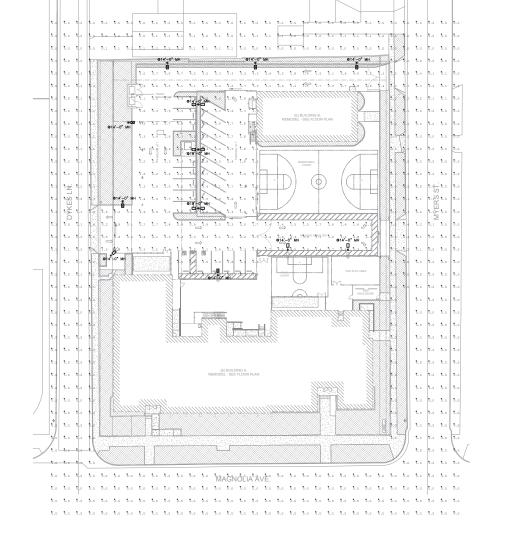
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CONSTRUCTION DOCUMENTS

SCHOLARSHIP PREP RIVERSIDE 9707 MAGNOLIA AVENUE RIVERSIDE, CA 92503

LIGHTING SITE PHOTOMETRICS PLAN





Project	Catalog #	Туре	
Prepared by	Notes	Date	



# **McGraw-Edison**

## **GALN Galleon II**

Area / Site Luminaire

#### **Product Features**









- Ordering Information page 2
- Mounting Details page 3
- Optical Distributions page 5
- Product Specifications page 5
- Energy and Performance Data page 6
- Control Options page 11

### **Product Certifications**

















### **Quick Facts**


- Lumen packages range from 3,300 73,500 (33W 552W)
- 17 optical distributions
- Efficacy up to 159 lumens per watt


# Connected Systems

- WaveLinx Lite
- WaveLinx Pro

#### **Dimensional Details**



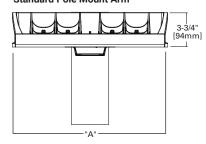

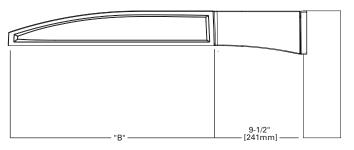


Number of Light Squares	Width "A"	Housing Length "B"	Weight with Standard or QM Arm	EPA with Standard or QM Arm			
1-4	16"	22"	29 lb	0.95			
5-6	22"	22"	39 lb	0.95			
7-9	22"	28-1/8"	48 lb	1.1			
NOTES: For arm selection requirements and additional line art, see Mounting Details section.							

1. Visit <a href="https://www.designlights.org/search/">https://www.designlights.org/search/</a> to confirm qualification. Not all product variations are DLC qualified 2. IDA Certified (3000K CCT and warmer only, fixed mounting options)



### Pole Drilling Pattern

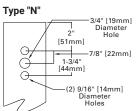

### **Ordering Information**

SAMPLE NUMBER: GALN-SA4C-740-U-T4FT-GM

Product Family 1,2	Light I	Engine	Color	Voltage	e Distribution		Mounting	Finish
Product Family "	Configuration	Drive Current	Temperature	voltage			Mounting	Finish
GALN=Galleon II BAA-GALN=Galleon II Buy American Act Compliant <sup>28</sup> TAA-GALN=Galleon II Trade Agreements Act Compliant <sup>26</sup>	SA1=1 Square SA2=2 Squares SA3=3 Squares SA4=4 Squares SA5=5 Squares SA6=6 Squares SA7=7 Squares SA8=8 Squares SA9=9 Squares	A=600mA B=800mA C=1000mA D=1200mA 4.16 Z=Configured <sup>32</sup>	722=70CRI, 2200K 727=70CRI, 2700K 730=70CRI, 3000K 735=70CRI, 3500K 740=70CRI, 4500K 750=70CRI, 5000K 750=70CRI, 5000K 827=80CRI, 2700K 835=80CRI, 3500K 840=80CRI, 3500K 840=80CRI, 3000K 935=90CRI, 3500K 940=90CRI, 3500K	U=120-277V H=347V-480V <sup>7,29</sup> 1=120V 2=208V 3=240V 4=277V 8=480V <sup>7,29</sup> 9=347V <sup>7</sup> DV=277V-480V DuraVolt Drivers <sup>23, 29, 30</sup>	T2-Type   II   T3-Type   II   T3-T		PA=Pole Mount, Adjustable SP=3" Slipfitter, Adjustable <sup>8</sup> SP2=2-3/8" Slipfitter, Adjustable <sup>8</sup> QMA=Quick Mount Mast Arm,	AP=Grey BZ=Bronze BK=Black DP=Dark Platinum GM=Graphite Metallic WH=White RALXX=Custom Color
Optio	ns (Add as Suffix)		Controls and Systems Options (Add as Suffix)				Accessories (Order Separately) 27	
Options (Add as Suffix)  DIM=External 0-10V Dimming Leads <sup>19</sup> F=Single Fuse (120, 277 or 347V Specify Voltage) FF=Double Fuse (208, 240 or 480V Specify Voltage) 20K=20kV U1 1449 fused surge protective device <sup>10</sup> 21_Two Circuits <sup>10</sup> HA=50°C High Ambient HSS=Installed House Side Shield <sup>17</sup> GRSBK=Glare Reducing Shield, Black <sup>22</sup> GRSWH-Glare Reducing Shield, White <sup>22</sup> LCF=Light Square Trim Painted to Match Housing <sup>25</sup> TH=Tool-less Door Hardware <sup>5</sup> CC=Coastal Construction finish <sup>3</sup> L90=Optics Rotated 90° Left R90=Optics Rotated 90° Right AHD145=After Hours Dim, 5 Hours <sup>21</sup> AHD255=After Hours Dim, 6 Hours <sup>21</sup> AHD255=After Hours Dim, 7 Hours <sup>21</sup> AHD255=After Hours Dim, 8 Hours <sup>21</sup> AHD355=After Hours Dim, 8 Hours <sup>21</sup> DALI=DALI Drivers			PR=NEMA 3-PÍN Photocon PR7=NEMA 7-PIN Photocon FADC=Field Adjustable Dim PSC=Photocontrol Shortin SPB2=Dimming Motion Se SPB4=Dimming Motion Se SPB4-Dimming Motion Se SPB4/X=Dimming Motion Sens Ms/DIM-L20=Motion Sens Ms/DIM-L40=Motion Sens Ms/DIM-L40=Motion Sens Ms/DIM-L40=Motion Sens Ms/DIM-L40=Motion Sens Ms/SXX=WaveLinx Lite, SI Programmable, 7' - 15' Mou WLS4XX=WaveLinx Lite, SI Programmable, 7' - 15' Mou WPS2XX=WaveLinx Pro, SI Programmable, 7' - 15' Mou WPS4XX=WaveLinx Pro, SI Programmable, 7' - 15' Mou WPS4XX=WaveLinx Pro, SI Programmable, 7' - 15' Mou WPS4XX=WaveLinx Pro, SI Programmable, 7' - 15' Mou WPS4XZ=WaveLinx Pro, SI Programmable, 7' - 12' Mou W	ntrol Receptacle <sup>20</sup> grap grap nsor, 9'-20' mounting <sup>23</sup> nsor, 21'-40' mounting <sup>23</sup> Sensor, limited square count, Sensor, limited square count, or for Dimming Operation, 9'- or for Dimming Operation, 21' R Driver, Dimming Motion and unting <sup>18, 12, 34</sup> R Driver, Dimming Motion and unting <sup>18, 12, 34</sup> R Driver, Dimming Motion and unting <sup>18, 12, 34</sup> R Driver, Dimming Motion and unting <sup>18, 12, 13, 18</sup> R Driver, Dimming Motion and unting <sup>18, 12, 13, 18</sup> R Driver, Dimming Motion and unting <sup>18, 12, 13, 18</sup> R Driver, Dimming Motion and	9'-20' mounting <sup>23</sup> 21'-40' mounting <sup>23</sup> 10' Mounting <sup>23</sup> -40' Mounting <sup>33</sup> Daylight, Bluetooth Daylight, Bluetooth Daylight, WAC Daylight, WAC	OA/RA10 OA/RA10 OA/RA10 OA/RA10 OA/RA10 MA1252: MA1036- MA1037- MA1197- MA1189- MA1190- MA1191- MA1038- MA1039- MA1194- MA1195- SRA238= tenon FSIR-100 LS/HSS= LS/GRSB LS/GRSB LS/GRSB	16=NEMA Photocontrol Multi-Tap - 10 27=NEMA Photocontrol - 480V 01=NEMA Photocontrol - 347V 13=Photocontrol - 347V 13=Photocontrol Shorting Cap 14=120V Photocontrol =10kV Surge Module Replacement XX=Single Tenon Adapter for 2-3/8" O XX=2@180° Tenon Adapter for 2-3/8" O XX=2@0120° Tenon Adapter for 2-3/8" C XX=2@00° Tenon Adapter for 2-3/8" C XX=2@00° Tenon Adapter for 2-3/8" C XX=2@00° Tenon Adapter for 3-1/2" O XX=2@120° Tenon Adapter for 3-1/2" O XX=2@120° Tenon Adapter for 3-1/2" O XX=2@10° Tenon Adapter for 3-1/2" C XX=2@00° Tenon Adapter for 3-1/2" C	D. Tenon O.D. Tenon O.D. Tenon O.D. Tenon D. Tenon D. Tenon O.D. T

- Customer is responsible for engineering analysis to confirm pole and fixture compatibility for all applications. Refer to our white paper WP513001EM for additional support information. DesignLights Consortium® Qualified. Refer to www.designlights.org Qualified Products List under Family Models for details. Coastal construction finish salt spray tested to over 5,000-hours per ASTM B117, with a scribe rating of 9 per ASTM D1654. Not available with TH option. Drive current 1200mA not available with color temperatures 722, 727, 827, 830 or 930 when the HSS option is selected. The action and 120 stread Net available with color temperatures 722, 727, 827, 830 or 930 when the HSS option is selected.

- Drive current 1200/IA not available with Coastal Construction (CC) option.

  Not available with voltage options H, 8 or 9.

  Requires the use of an internal step down transformer when combined with sensor options. Not available in combination with the HA high ambient and sensor options at 1A.

  SP arm limited to 3" 0.D. vertical tenon. SP2 limited to 2-3/8" 0.D. vertical tenon.

  One required for each Light Scurage.

- SP arm limited to 3" O.D. vertical tenon. SP2 limited to 2-3/8" O.D. vertical tenon.

  One required for each Light Square.

  2L is not available with SPB at 347V or 480V. Not available with WaveLinx or Enlighted sensors, or 20kV surge option Requires PK7.

  Replace XX with sensor color (WH, BZ or BK.)

  WAC Gateway required to enable field-configurability: Order WAC-PoE and WPOE-120 (10V to PoE injector) power supply if needed. WAC not required for I.C Bluetooth sensors.

  Narrow-band 590mm 4"- 5mm for wildlife and observatory use. Choose drive current A; supplied at 500mA drive current only. Exact luminaire wattage available in IES files. Available with SWQ, SMQ, SL2, SL3 and SL4 distributions. Can be used with HSS option.
- Set of 4 pcs. One set required per Light Square.
- Not available with HA option.

  Not for use with T1, 5NQ, 5MQ, 5WQ or RW optics.

- Cannot be used with other control options.

  Low voltage control lead brought out 18" outside fixture. Not available with DALI or integrated controls options

  Not available if any SPB, LWR, or WaveLinx sensor is selected. Motion sensor has an integral photocell.

  Requires the use of BPC photocontrol or the PR7 or PR photocontrol receptacle with photocontrol accessory.

  Not for use with 11, 14F1, TAW or SL4 optics.

  Sensor configuration mobile application required for configuration. See controls page for details.

  Replace X with number of Light Squares controlled by the SPB, referencing the "SPB/X Availability Table" on the controls page.

  Not available with HSS, GRSWH or GRSBK.
- Only product configurations with these designated prefixes are built to be compliant with the Buy American Act of 1933 (BAA) or
- Only product configurations with these designated prefixes are built to be compliant with the Buy American Act of 1933 (BAA) or Trade Agreements Act of 1977 (TAA), respectively. Please refer to <u>DOMESTIC PREFERENCES</u> website for more information. Components shipped separately may be separately analyzed under domestic preference requirements.

  For BAA or TAA requirements, Accessories sold separately will be separately analyzed under domestic preference requirements.

  Consult factory for further information.

  DuraVolt drivers feature added protection from power quality issues such as loss of neutral, transients and voltage fluctuations. Visit <a href="https://www.signity.com/durayoit">www.signity.com/durayoit for more information.</a>

  480V not to be used with ungrounded or impedance grounded systems.

  Not available in 1 square configuration at 800mA or below. Not available with any control option except SPB.

  Cannot be used with PR7 or other motion response control options.

- Laminot be used with PK7 or other motion response control options.
   Use GALN Product Configurator to specify lumen output, drive current and wattage. Not available with AMB.
   Uses the FSP-211 motion sensor. The FSIR-100 configuration tool is required to adjust parameters including high and low modes, sensitivity, time delay, cutoff and more. Consult your lighting representative at Cooper Lighting Solutions for more information.
   Controls system is not available with photocontrol receptacles (PR, PR7) or other controls systems (FADC, SPBx).

#### LumenSafe Integrated Network Security Camera Technology Options (Add as Suffix)

Product Family	Camera Type	Da	ta Backhaul
	D=Standard Dome Camera H=Hi-Res Dome Camera Z=Remote PTZ Camera	C=Cellular, No SIM A=Cellular, AT&T Y=Cellular, Verizon S=Cellular, Sprint	R=Cellular, Rogers W=Wi-Fi Networking w/ Omni-Directional Antenna E=Ethernet Networking

